

PROJECT: ATT MNP (NB) SMALL CELL

MNL06635F_R01/MNL06634F_R02/MNL06635F_R03/MNL06636F_R01 SITE #:

FA #: 13931784

PACE #: MRUMW017659/MRUMW017662/MRUMW017666/MRUMW017671

PTN #: 3511A09R84/3511A09R63/3511A09R83/3511A09R82

USID#: 182101/182102/181103/182390

CRAN RUMW MOAMN 008/CRAN RUMW MOAMN 009/ SITE NAME: CRAN RUMW MOAMN 010/CRAN RUMW MOAMN 011

SITE TYPE: ROOFTOP

SITE ADDRESS: HYATT REGENCY BLOOMINGTON-MINNEAPOLIS

> 3200 E 81ST STREET **BLOOMINGTON, MN 55425**

JURISDICTION: **BLOOMINGTON** 540 W. MADISON ST. 17TH FLOOR CHICAGO, IL 60661

901 S. MARQUETTE AVENUE MINNEAPOLIS, MN 55402

MOBILITY

I 100 E. WOODFIELD ROAD, SUITE 500 SCHAUMBURG, ILLINOIS 60173 TEL: 847-908-8400

www.FullertonEngineering.com

90% REVIEW 100% REVIEW REVISION REVISION

HEREBY CERTIFY THAT THESE DRAWINGS WEF PREPARED BY ME OR UNDER MY DIRECT UPFRVISION AND CONTROL, AND TO THE BES OF MY KNOWLEDGE AND BELIEF COMPLY WITH THE REQUIREMENTS OF ALL APPLICABLE CODES

> I hereby certify that this plan, specification, or report was prepared by me or under my direct supervision and that I am a duly Licensed Professional Engineer under the laws of the State of Minnesota

Henry M. Bellagamba

License # 43012

CRAN RUMW MOAMN 008/ CRAN RUMW MOAMN 009/ CRAN RUMW MOAMN 010/ CRAN_RUMW_MOAMN_011

PACE NUMBER

MRIMW017659/MRUMW017662 MRUMW017666/MRUMW017671

SITE ADDRESS

3200 E 81ST STREET BLOOMINGTON, MN 55425

SHEET NAME

TITLE SHEET

SHEET NUMBER

PROJECT INFORMATION SCOPE OF WORK APPLICABLE BUILDING CODES AND STANDARDS ATT MNP (NB) SMALL CELL THE SCOPE OF WORK CONSISTS OF ALL WORK AND MATERIALS SHALL BE PERFORMED AND INSTALLED IN ACCORDANCE WITH THE 13931784 CURRENT EDITIONS OF THE FOLLOWING CODES AS ADOPTED BY THE LOCAL GOVERNING FA #: INSTALL (4) NEW PANEL ANTENNAS 182101/182102/181103/182390 **ALITHORITIES** INSTALL (4) NEW 1900 RRH UNITS MRUMW017659/MRUMW017662/MRUMW017666/MRUMW01767 . INSTALL (4) NEW 700 RRH UNITS BUILDING CODE: 2015 MINNESOTA BUILDING CODE 3511A09R84/3511A09R63/3511A09R83/3511A09R82 • INSTALL (1) NEW CABINET SITE ADDRESS: HYATT REGENCY BLOOMINGTON-MINNEAPOLIS INSTALL DC POWER AND FIBER CABLES ELECTRICAL CODE: 2017 NATIONAL ELECTRICAL CODE 3200 E 81ST STREET • INSTALL ARGUS SHELF IN CABINET WITH (4) NEW CONVERTERS BLOOMINGTON, MN 55425 **COUNTY:** HENNEPIN JURISDICTION: BLOOMINGTON APPLICANT: AT&T WIRELESS CONTRACTOR SHALL FURNISH ALL MATERIAL WITH THE EXCEPTION OF AT&T SUPPLIED FACILITY IS UNMANNED AND NOT FOR HUMAN HABITATION. 901 S. MARQUETTE AVE. ADA ACCESS REQUIREMENTS ARE NOT REQUIRED. MINNEAPOLIS, MN 55402 ALL MATERIAL SHALL BE INSTALLED BY THE CONTRACTOR, UNLESS STATED OTHERWISE THIS FACILITY DOES NOT REQUIRE POTABLE WATER AND WILL NOT PRODUCE ANY SEWAGE LATITUDE: 44.86109 SITE LOCATION MAP DRAWING INDEX ONGITUDE -93.22742 GROUND ELEV. (A.M.S.L.): 798 TITLE SHEET

93.22742 al decide to Alexander Property Market St. COULDANT THE HARVER ATTEMPT OF THE STREET Green Carling and Michigan

DIRECTIONS SCAN QR CODE FOR LINK TO SITE LOCATION MAP

GENERAL NOTES

ANTENNA LAYOUT AND DETAILS

ROOF PLAN

SITE DETAILS

EUIPMENT DETAILS

ELEVATION

N-1

C-1

C-2

C-3

C-5

NO SCALE

Know what's below. Call before you dig.

DRAWINGS SCALED TO 11"x17"

PROJECT CONSULTANTS

2737 FAIRVIEW AVENUE N ST. PAUL. MN 55113

BLOOMINGTON CENTRAL STATION HOTEL, LLC

WALT LODERMEIER (651) 634-7718 TELECOMMUNICATIONS FACILITY

AT&T CONSTRUCTION

PROPERTY OWNER:

LANDLORD CONTACT:

PROPOSED USE:

AUSTIN N. BRUNKEN MANAGER: PHONE: (605) 335-8209 EMAIL: AB923@ATT.COM

AT&T PROJECT MARIA A. BURMEISTER

MANAGER: SENIOR C&E PROJECT MANAGER PHONE:

(952) 221-9291 MB018V@ATT.COM EMAIL:

PROJECT MANAGER **ADDRESS**

SAC WIRELESS 540 W. MADISON ST. 17TH FLOOR CHICAGO, IL 60661

CONTACT AMY HUTCHINGS EMAIL: amy.hutchings@sacw.com

SITE ACQUISITION: SAC WIRELESS

540 W. MADISON ST. 17TH FLOOR CHICAGO, IL 60661 ADDRESS:

PETER TESSLER peter.tessler@sacw.com

ENGINEER/ARCHITECT:

CONTACT:

EMAIL:

FULLERTON ENGINEERING ADDRESS:

1100 E. WOODFIELD RD., SUITE 500 SCHAUMBURG, IL 60173

CONTACT HILDA ALLAWIRDI PHONE: (847) 908-8413

FMAIL: hallawirdi@fullertonengineering.com

SAC WIRELESS CONSTRUCTION

4300 MARKET POINTE DRIVE ADDRESS: MINNEAPOLIS, MN 55435

CONTACT: RITA STOLZ rita.stolz@sacw.com **EMAIL:**

PROJECT# 2017.0301.3009

GENERAL:

- THE CONTRACTOR SHALL BE RESPONSIBLE FOR FOLLOWING ALL LAWS, REGULATIONS, AND RULES SET FORTH BY FEDERAL, STATE, AND LOCAL AUTHORITIES WITH JURISDICTION OVER THE PROJECT. THIS RESPONSIBILITY IS IN EFFECT REGARDLESS OF WHETHER THE LAW, ORDINANCE, REGULATION OR RULE IS MENTIONED IN THESE SPECIFICATIONS.
- ALL WORK SHALL BE COMPLETED AS INDICATED ON THE DRAWINGS, AT&T PROJECT SPECIFICATIONS. AND THE CONSTRUCTION CONTRACT DOCUMENTS.
- THE CONTRACTOR SHALL HAVE AND MAINTAIN A VALID CONTRACTOR'S LICENSE FOR THE LOCATION IN WHICH THE WORK IS TO BE PERFORMED. FOR JURISDICTIONS THAT LICENSE INDIVIDUAL TRADES, THE TRADESMAN OR SUBCONTRACTOR PERFORMING THOSE TRADES SHALL BE LICENSED.
- FOLLOW ALL APPLICABLE RULES AND REGULATIONS OF THE OCCUPATIONAL SAFETY AND HEALTH ADMINISTRATION (OSHA) AND STATE LAW AS DEFINED IN THE FEDERAL OCCUPATIONAL SAFETY AND HEALTH ACT.
- 5. PRIOR TO THE SUBMISSION OF THE BID, THE CONTRACTOR SHALL VISIT THE JOB SITE, VERIFY ALL DIMENSIONS AND BECOME FAMILIAR WITH THE FIELD CONDITIONS. ANY DISCREPANCIES SHALL BE BROUGHT TO THE ATTENTION OF THE PROJECT MANAGER.
- 6. DRAWING PLANS SHALL NOT BE SCALED.
- THE CONTRACTOR SHALL NOT PROCEED WITH ANY WORK NOT CLEARLY IDENTIFIED ON THE DRAWINGS WITHOUT THE PRIOR WRITTEN APPROVAL OF THE PROJECT MANAGER.
- THE CONTRACTOR SHALL INSTALL ALL EQUIPMENT AND MATERIALS IN ACCORDANCE WITH MANUFACTURER RECOMMENDATIONS UNLESS SPECIFICALLY OTHERWISE NOTED.
- ALL MEANS AND METHODS OF CONSTRUCTION DEALING WITH TOWER CONSTRUCTION AND SAFETY, STEEL ERECTION, EXCAVATIONS, TRENCHING, SCAFFOLDING, FORMWORK, ELECTRICAL, AND WORK IN CONFINED SPACES ARE THE SOLE RESPONSIBILITY OF THE CONTRACTOR.
- 10. WHEN THE CONTRACTOR ACTIVITIES IMPEDE OR OBSTRUCT TRAFFIC FLOW, CONTRACTOR SHALL PROVIDE TRAFFIC CONTROL DEVICES, SIGNS, AND FLAGMEN IN ACCORDANCE WITH APPLICABLE FEDERAL, STATE, DOT AND LOCAL REQUIREMENTS.
- 11. THE CONTRACTOR SHALL COORDINATE SITE ACCESS AND SECURITY WITH THE PROPERTY OWNER AND THE PROJECT MANAGER PRIOR TO CONSTRUCTION.
- 12. THE CONTRACTOR SHALL BE RESPONSIBLE FOR COORDINATION WITH UTILITIES.
- THE CONTRACTOR SHALL CALL THE LOCAL PUBLIC UTILITY LOCATING PROVIDER (811) A MINIMUM OF THREE BUSINESS DAYS PRIOR TO EXCAVATING IN THE PUBLIC RIGHT OF WAY.
- 14. THE CONTRACTOR SHALL BE RESPONSIBLE FOR LOCATING PRIVATE UTILITIES.
- 15. THE CONTRACTOR SHALL PROVIDE ANY TEMPORARY UTILITIES OR FACILITIES IT DEEMS NECESSARY TO COMPLETE THE WORK. THIS INCLUDES, BUT IS NOT LIMITED TO WATER, SEWER, POWER, TELEPHONE, HEAT, LIGHTING OR SECURITY.
- 16. WHEN EXCAVATING IN THE AREA OF EXISTING UTILITIES, THE CONTRACTOR SHALL USE REASONABLE CARE IN PROTECTING SUCH UTILITIES. CONTRACTOR SHALL NOTIFY THE PROJECT MANAGER IMMEDIATELY OF ANY CONFLICTS BETWEEN EXISTING UTILITIES AND PROPOSED CONSTRUCTION.
- 17. DAMAGE TO PUBLIC OR PRIVATE UTILITIES SHALL BE REPORTED TO THE PROJECT MANAGER AND THE OWNER OF THE UTILITY IMMEDIATELY. ANY DAMAGE RESULTING FROM CONTRACTORS NEGLIGENCE OR FAILURE TO ACT WITH DUE REGARD SHALL BE REPAIRED AT CONTRACTORS EXPENSE.
- 18. UNLESS OTHERWISE NOTED ON THE PLANS, CONTRACTOR SHALL ASSUME ALL SURFACE FEATURES SUCH AS BUT NOT LIMITED TO BUILDINGS, PAVEMENTS, LANDSCAPING FEATURES, PLANTS, ETC. ARE TO BE SAVED AND PROTECTED FROM DAMAGE. CONTRACTOR SHALL MAKE NECESSARY PROVISIONS TO PROTECT EXISTING SITE CONDITIONS AND UPON COMPLETION OF WORK REPAIR BACK TO ORIGINAL CONDITIONS ANY DAMAGE THAT OCCURRED DURING CONSTRUCTION.
- 19. KEEP THE CONSTRUCTION SITE CLEAN, HAZARD FREE, AND DISPOSE OF ALL DIRT, DEBRIS, RUBBISH AND REMOVE EQUIPMENT NOT SPECIFIED AS REMAINING ON THE PROPERTY. LEAVE PREMISES IN CLEAN CONDITION AND SHALL BE SUBJECT TO APPROVAL BY THE PROPERTY OWNER AND THE PROJECT MANAGER.
- THE CONTRACTOR SHALL PROVIDE ON-SITE TRASH RECEPTACLES FOR COLLECTION OF NON-TOXIC DEBRIS. ALL TRASH SHALL BE COLLECTED ON A DAILY BASIS.
- 21. ALL TOXIC AND ENVIRONMENTALLY HAZARDOUS SUBSTANCES SHALL BE USED AND DISPOSED OF IN ACCORDANCE WITH MANUFACTURER SPECIFICATIONS. UNDER NO CIRCUMSTANCES SHALL RINSING OR DUMPING OF THESE SUBSTANCES OCCUR ON—SITE.
- 22. UNLESS NOTED OTHERWISE, CONTRACTOR SHALL BE RESPONSIBLE FOR OBTAINING AND PAYING FOR ALL PERMITS NECESSARY FOR CONSTRUCTION.
- 23. THE PROJECT MANAGER MAY RETAIN THE SERVICES OF A TESTING LABORATORY TO PERFORM QUALITY ASSURANCE TESTING ON VARIOUS PORTIONS OF THE CONTRACTORS WORK. WHEN REQUESTED, THE CONTRACTOR SHALL INFORM THE TESTING LABORATORY AND ASSIST THEM IN COMPLETING TESTS.
- 24. THE CONTRACTOR SHALL MAINTAIN AND SUPPLY THE PROJECT MANAGER WITH AS-BUILT PLANS UPON COMPLETION OF THE PROJECT.

ELECTRIC:

- THE CONTRACTOR SHALL PERFORM WORK IN ACCORDANCE WITH ALL GOVERNING STATE, COUNTY AND LOCAL CODES AND OSHA REQUIREMENTS.
- 2. THE ENTIRE ELECTRICAL INSTALLATION SHALL BE GROUNDED AS REQUIRED BY ALL APPLICABLE CODES
- 3. THE CONTRACTOR SHALL PROVIDE ALL LABOR, MATERIALS, INSURANCE, EQUIPMENT, INSTALLATION, CONSTRUCTION TOOLS AND TRANSPORTATION FOR A COMPLETE AND PROPERLY OPERATIVE SYSTEM ENERGIZED THROUGHOUT AND AS INDICATED ON DRAWINGS.
- 4. THE CONTRACTOR SHALL OBTAIN ALL PERMITS, PAY PERMIT AND INSPECTION FEES, AND BE RESPONSIBLE FOR SCHEDULING INSPECTIONS WITH THE AUTHORITY HAVING JURISDICTION.
- MATERIALS SHALL BE MANUFACTURED IN ACCORDANCE WITH APPLICABLE STANDARDS ESTABLISHED BY ANSI, IEEE, NEMA AND NFPA.
- 6. ALL MATERIALS SHALL BE U.L. LISTED.
- ALL MATERIALS AND EQUIPMENT SHALL BE NEW AND IN PERFECT CONDITION WHEN INSTALLED AND SHALL BE OF THE BEST GRADE AND OF THE SAME MANUFACTURER THROUGHOUT FOR EACH CLASS OR GROUP OF EQUIPMENT.
- 8. MATERIALS SHALL MEET WITH APPROVAL OF THE AUTHORITY HAVING JURISDICTION.
- THE CONTRACTOR SHALL PERFORM ALL VERIFICATION OBSERVATIONS TEST, AND EXAMINATION WORK PRIOR TO THE ORDERING OF THE ELECTRICAL EQUIPMENT AND STARTING CONSTRUCTION. CONTRACTOR SHALL ISSUE A WRITTEN NOTICE OF ALL FINDINGS TO THE PROJECT MANAGER LISTING ALL MALFUNCTIONS, FAULTY EQUIPMENT AND DISCREPANCIES.
- 10. THE CONTRACTOR SHALL COORDINATE WITH UTILITY COMPANY FOR CONNECTION OF THE TEMPORARY AND PERMANENT POWER TO THE SITE. THE TEMPORARY POWER AND ALL HOOKUP COSTS TO BE PAID BY CONTRACTOR.
- UPON COMPLETION OF WORK, CONDUCT CONTINUITY, SHORT CIRCUIT, AND FALL OF POTENTIAL GROUND TESTS FOR APPROVAL. SUBMIT TEST REPORTS TO THE PROJECT MANAGER.
- 12. ALL BROCHURES, OPERATING MANUALS, CATALOGS, SHOP DRAWINGS, ETC. SHALL BE TURNED OVER TO THE PROJECT MANAGER AT JOB COMPLETION.
- 13. POST-INSTALLATION, ANY WORK, MATERIAL OR EQUIPMENT FOUND TO BE FAULTY SHALL BE CORRECTED AT ONCE, UPON WRITTEN NOTIFICATION, AT THE EXPENSE OF THE CONTRACTOR.
- 14. PROVIDE THE PROJECT MANAGER WITH ONE SET OF COMPLETE ELECTRICAL "AS—INSTALLED" DRAWINGS AT THE COMPLETION OF THE JOB, SHOWING ACTUAL DIMENSIONS, ROUTINGS AND CIRCUITS.
- 15. ALL ELECTRICAL EQUIPMENT SHALL BE LABELED WITH PERMANENT ENGRAVED PLASTIC LABELS NOTING USE FUNCTION.
- EACH CONDUCTOR OF EVERY SYSTEM SHALL BE PERMANENTLY TAGGED IN EACH PANEL BOARD, PULL BOX, J-BOX, SWITCH BOX, ETC.
- ALL CONDUIT INSTALLED SHALL BE SURFACE MOUNTED OR DIRECT BURIAL UNLESS OTHERWISE NOTED.
- 18. ALL CONDUIT SHALL HAVE A PULL WIRE OR ROPE.
- 19. ALL CONDUCTORS SHALL BE COPPER.
- 20. ALL CIRCUIT BREAKERS, FUSES AND ELECTRICAL EQUIPMENT SHALL HAVE AN INTERRUPTING SHORT CIRCUIT CURRENT TO WHICH THEY MAY BE SUBJECTED, AND A MINIMUM OF 10,000 A.I.C.
- 21. PATCH, REPAIR AND PAINT ANY AREA THAT HAS BEEN DAMAGED IN THE COURSE OF THE ELECTRICAL WORK.
- 22. PENETRATIONS IN FIRE RATED WALLS SHALL BE FIRE STOPPED TO MATCH ORIGINAL RATING.
- 23. BX OR ROMEX CABLE IS NOT PERMITTED.
- ALL ELECTRICAL/FIBER ENCLOSURES, JUNCTION BOXES, CONDUIT KNOCKOUTS, RACEWAYS, ETC. SHALL BE RODENT-PROOF.
- 25. CLEAN PREMISES OF ALL DEBRIS RESULTING FROM WORK AND LEAVE WORK IN A COMPLETE AND UNDAMAGED CONDITION.





FULLERTON

I 100 E. WOODFIELD ROAD, SUITE 500 SCHAUMBURG, ILLINOIS 60173 TEL: 847-908-8400 www.FullertonEngineering.com

REV	DATE	DESCRIPTION	BY	
А	11/14/17	90% REVIEW	AA	
В	11/30/17	100% REVIEW	AA	
0	12/15/17	FINAL	ЕМ	
1	1/17/18	REVISION	AA	
2	3/22/18	REVISION	AΑ	

I HEREBY CERTIFY THAT THESE DRAWINGS WERI PREPARED BY ME OR UNDER MY DIRECT SUPERVISION AND CONTROL, AND TO THE BEST OF MY KNOWLEDGE AND BELIEF COMPLY WITH THE REQUIREMENTS OF ALL APPLICABLE CODES

> I hereby certify that this plan, specification, or report was prepared by me or under my direct supervision and that I am a duly Licensed Professional Engineer under the laws of the State of Minnesota

Henry M. Bellagamba License # 43012

m. Belger

SITE NAME

CRAN_RUMW_MOAMN_008/ CRAN_RUMW_MOAMN_019/ CRAN_RUMW_MOAMN_010/ CRAN_RUMW_MOAMN_011

PACE NUMBER

MRIMW017659/MRUMW017662 MRUMW017666/MRUMW017671

SITE ADDRESS


3200 E 81ST STREET BLOOMINGTON, MN 55425

SHEET NAME

GENERAL NOTES

SHEET NUMBER

N-1

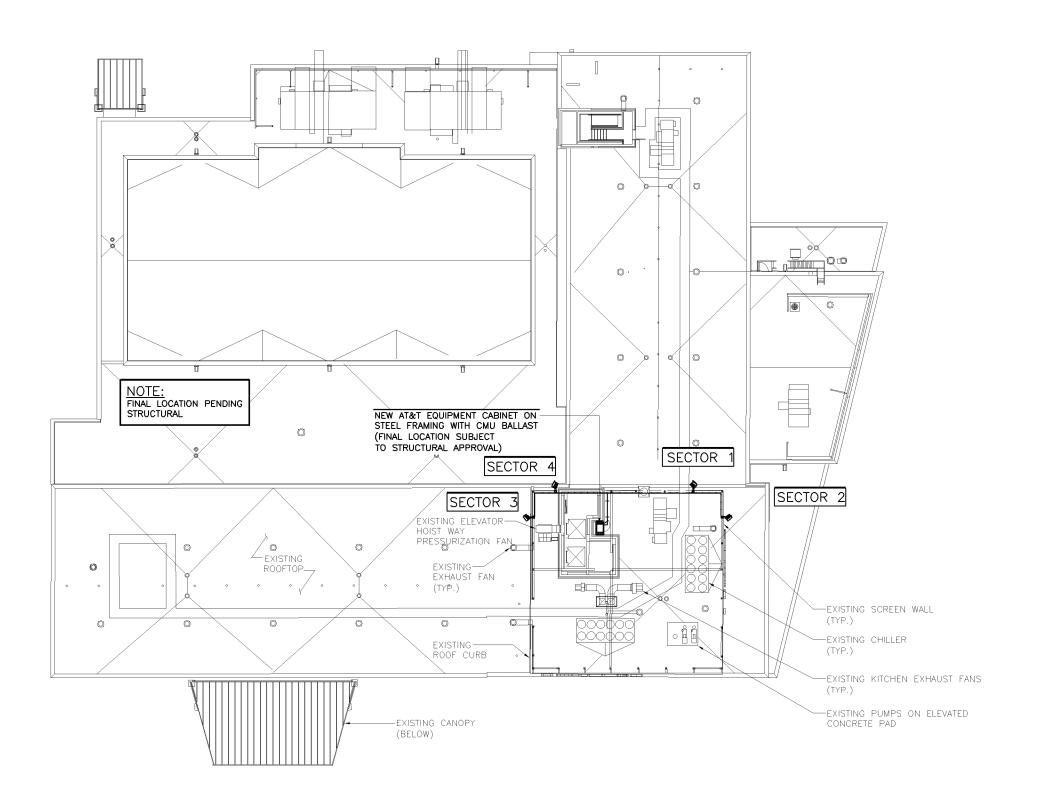





540 W. MADISON ST. 17TH FLOOR CHICAGO, IL 60661

FULLERTON

I 100 E. WOODFIELD ROAD, SUITE 500 SCHAUMBURG, ILLINOIS 60173 TEL: 847-908-8400 www.FullertonEngineering.com

REV	DATE	DESCRIPTION	BY		
Α	11/14/17	90% REVIEW	AΑ		
В	11/30/17	100% REVIEW	AΑ		
0	12/15/17	FINAL	ЕМ		
1	1/17/18	REVISION	AA		
2	3/22/18	REVISION	AΑ		

I HEREBY CERTIFY THAT THESE DRAWINGS WERE PREPARED BY ME OR UNDER MY DIRECT SUPERVISION AND CONTROL, AND TO THE BEST OF MY KNOWLEDGE AND BELIEF COMPLY WITH THE REQUIREMENTS OF ALL APPLICABLE CODES.

> I hereby certify that this plan, specification, or report was prepared by me or under my direct supervision and that I am a duly Licensed Professional Engineer under the laws of the State of Minnesota

Henry M. Bellagamba License # 43012

License # 43012 Light M. Belgh

SITE NAME

CRAN_RUMW_MOAMN_008/ CRAN_RUMW_MOAMN_009/ CRAN_RUMW_MOAMN_010/ CRAN_RUMW_MOAMN_011

PACE NUMBER:

MRIMW017659/MRUMW017662 MRUMW017666/MRUMW017671

SITE ADDRESS

3200 E 81ST STREET BLOOMINGTON, MN 55425


SHEET NAME

SITE PLAN



SHEET NUMBER

C-1

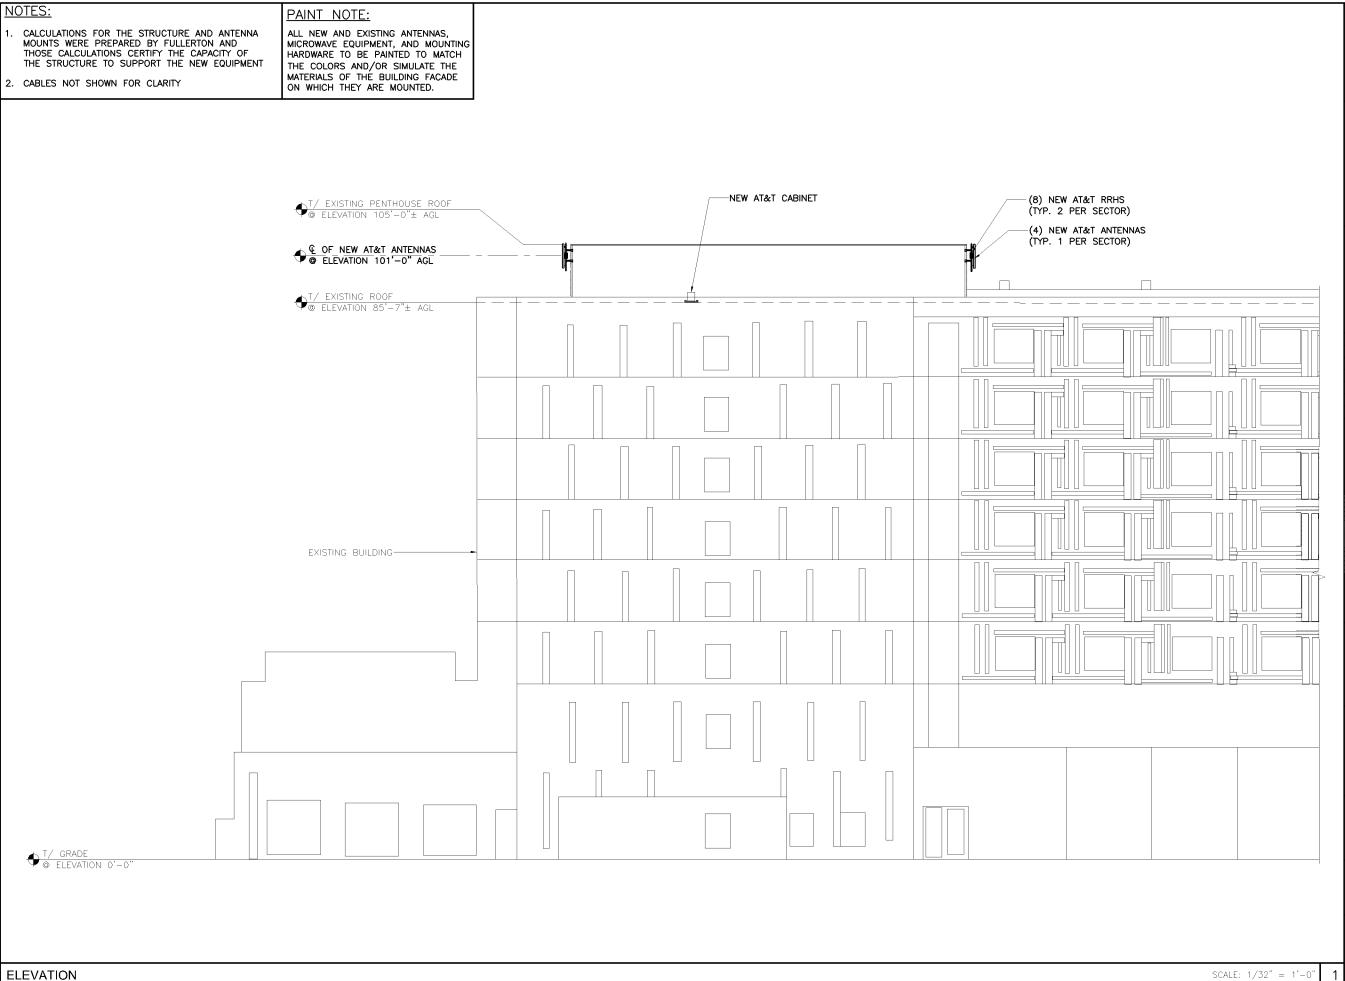





1100 E. WOODFIELD ROAD, SUITE 500 SCHAUMBURG, ILLINOIS 60173 TEL: 847-908-8400 www.FullertonEngineering.com

REV	DATE	DESCRIPTION	BY			
Α	11/14/17	90% REVIEW	ΑА			
В	11/30/17	100% REVIEW	AΑ			
0	12/15/17	FINAL	ΕM			
1	1/17/18	REVISION	AA			
2	3/22/18	REVISION	ΑА			

HEREBY CERTIFY THAT THESE DRAWINGS WER
PREPARED BY ME OR UNDER MY DIRECT
SUPERVISION AND CONTROL AND TO THE BES OF MY KNOWLEDGE AND BELIEF COMPLY WITH THE REQUIREMENTS OF ALL APPLICABLE CODES

I hereby certify that this plan, specification, or report was prepared by me or under my direct supervision and that I am a duly Licensed Professional Engineer under the laws of the State of Minnesota

Henry M. Bellagamba License # 43012

SITE NAME

CRAN_RUMW_MOAMN_008/ CRAN_RUMW_MOAMN_009/ CRAN_RUMW_MOAMN_010/ CRAN_RUMW_MOAMN_011

PACE NUMBER:

MRIMW017659/MRUMW017662 MRUMW017666/MRUMW017671


SITE ADDRESS

3200 E 81ST STREET BLOOMINGTON, MN 55425

SHEET NAME

ELEVATION

SHEET NUMBER

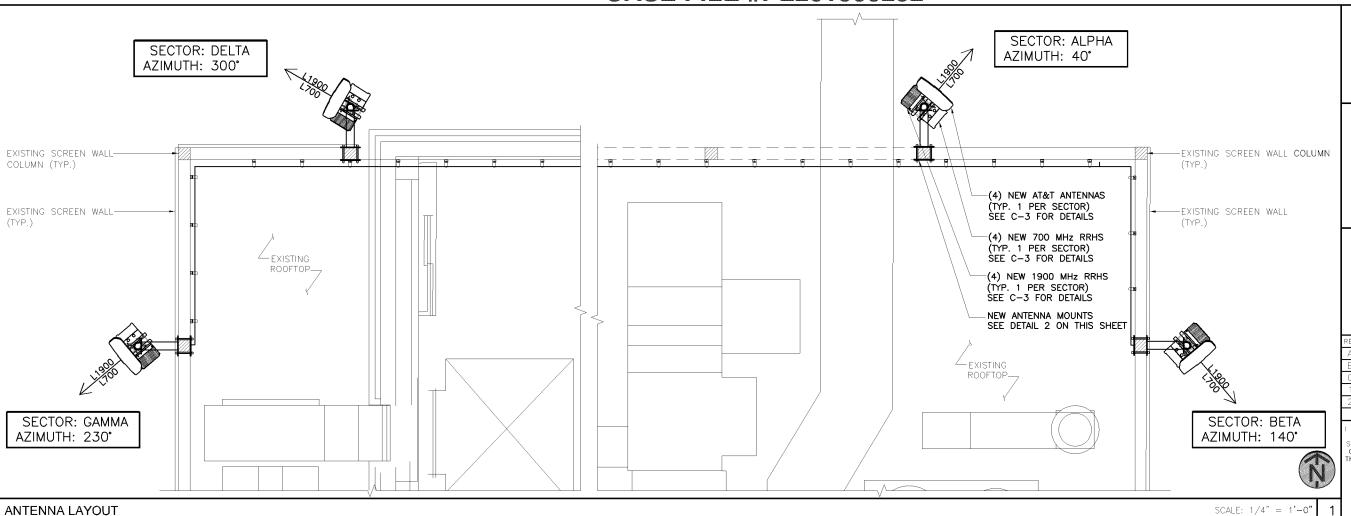

T/ EXISTING SCREEN WALL @ ELEVATION 105'-0"± AGL REMOVED EXISTING SHEET METAL SCREEN WALL AS REQUIRED FOR INSTALLATION OF NEW ANTENNA EXISTING CORRUGATED SHEET METAL SCREEN WALL MOUNT. NEW AT&T ANTENNA EXISTING 6"X6" STEEL COLUMN NEW 700 MHz RRHS (BEHIND) 1'-6" The antennas must be NEW 1/2"ø THROUGH BOLT painted to match the wall (TYP. OF 8 PER SECTOR) on which they are mounted. © OF NEW AT&T ANTENNAS © ELEVATION 101'-0" AGL NEW BACK PLATE PL 3/8"X10"X10" NEW 1900 MHz RRHS (TYP. OF 2 PER SECTOR) NEW COMMSCOPE ANTENNA MOUNT (P/N#MC-SA18-B) (TYP. OF 2 PER SECTOR) NEW ANTENNA MOUNT NEW BACK PLATE-

SCALE: 3/8" = 1'-0

(TYP. OF 2 PER SECTOR)

SEE DETAIL 3 ON THIS SHEET

NEW 2.0 STD (2-3/8" 0.D)
MOUNTING PIPE (9'-0" LENGTH)

SHEET METAL SCREEN WALL

EXISTING 6"X6" STEEL-

COLUMN

TYPICAL ANTENNA MOUNTING DETAIL





FULLERTON


1100 E. WOODFIELD ROAD, SUITE 500 SCHAUMBURG, ILLINOIS 60173 TEL: 847-908-8400 www.FullertonEngineering.com

REV	DATE	DESCRIPTION	BY
Α	11/14/17	90% REVIEW	AA
В	11/30/17	100% REVIEW	AA
0	12/15/17	FINAL	ЕМ
1	1/17/18	REVISION	AA
2	3/22/18	REVISION	AΑ

I HEREBY CERTIFY THAT THESE DRAWINGS WERE PREPARED BY ME OR UNDER MY DIRECT SUPERVISION AND CONTROL. AND TO THE BEST OF MY KNOWLEDGE AND BELIEF COMPLY WITH THE REQUIREMENTS OF ALL APPLICABLE CODES

> I hereby certify that this plan, specification, or report was prepared by me or under my direct supervision and that I am a duly Licensed Professional Engineer under the laws of the State of Minnesota

Henry M. Bellagamba License # 43012

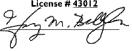

SITE NAM

CRAN_RUMW_MOAMN_008/ CRAN_RUMW_MOAMN_009/ CRAN_RUMW_MOAMN_010/ CRAN_RUMW_MOAMN_011

PACE NUMBER:

MRIMW017659/MRUMW017662 MRUMW017666/MRUMW017671

SITE ADDRESS


3200 E 81ST STREET BLOOMINGTON, MN 55425

SHEET NAM

ANTENNA LAYOUT
AND DETAILS

SHEET NUMBER

C-3

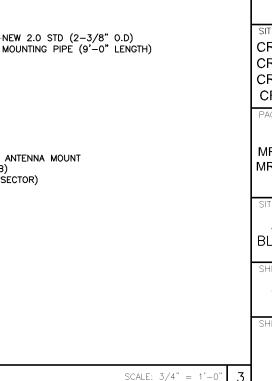


1 1/2"

10"

PL 3/8"X10"X10"

ANTENNA MOUNTING DETAILS

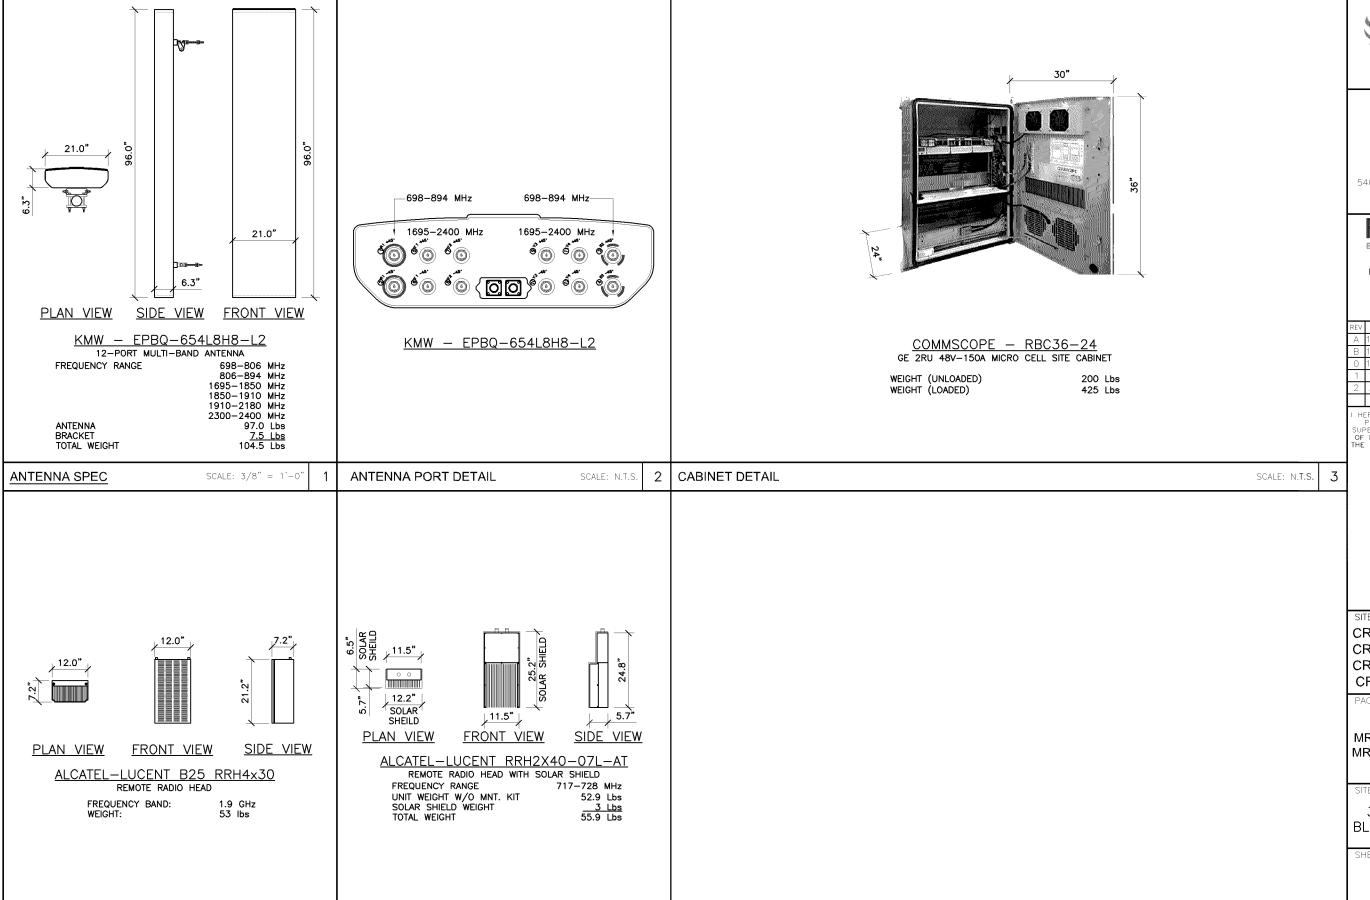

5

SCALE: 3/8" = 1'-0"

NOT USED

RRU SPECS

SCALE: 3/8" = 1'-0"

RRU SPECS





I 100 E. WOODFIELD ROAD, SUITE 500 SCHAUMBURG, ILLINOIS 60173 TEL: 847-908-8400 www.FullertonEngineering.com

REV	DATE	DESCRIPTION	BY
Α	11/14/17	90% REVIEW	AA
В	11/30/17	100% REVIEW	AΑ
0	12/15/17	FINAL	ЕМ
1	1/17/18	REVISION	AA
2	3/22/18	REVISION	AΑ

HEREBY CERTIFY THAT THESE DRAWINGS WER PREPARED BY ME OR UNDER MY DIRECT SUPERVISION AND CONTROL, AND TO THE BES OF MY KNOWLEDGE AND BELIEF COMPLY WITH THE REQUIREMENTS OF ALL APPLICABLE CODES

I hereby certify that this plan, specification, or report was prepared by me or under my direct supervision and that I am a duly Licensed Professional Engineer under the laws of the State of Minnesota

Henry M. Bellagamba

License # 43012

SITE NAME

CRAN RUMW MOAMN 008/ CRAN RUMW MOAMN 009/ CRAN RUMW MOAMN 010/ CRAN_RUMW_MOAMN_011

PACE NUMBER:

MRIMW017659/MRUMW017662 MRUMW017666/MRUMW017671

SITE ADDRESS


3200 E 81ST STREET BLOOMINGTON, MN 55425


SHEET NAME

SPECIFICATIONS

SHEET NUMBER

SCALE: N.T.S.

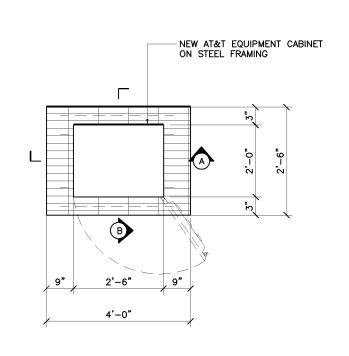

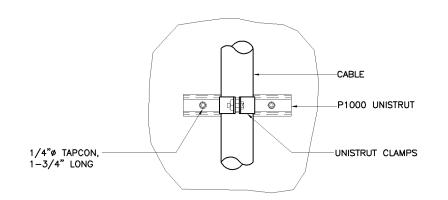





I 100 E. WOODFIELD ROAD, SUITE 500 SCHAUMBURG, ILLINOIS 60173 TEL: 847-908-8400 www.FullertonEngineering.com

		REV	DATE	DESCRIPTION	BY
		Α	11/14/17	90% REVIEW	AA
		В	11/30/17	100% REVIEW	AA
		0	12/15/17	FINAL	ЕМ
		1	1/17/18	REVISION	AA
	0	2	3/22/18	REVISION	AΑ
SCALE: N.T.S.	2				

EQUIPMENT CABINET PLAN SCALE: 3/8" = 1'-0"

CABLE SUPPORT DETAIL SYMBOL LEGEND:

EXOTHERMIC CONNECTION

MECHANICAL CONNECTION

INTERNAL EQUIPMENT GROUND BAR

GROUND BAR

#2 AWG STRANDED INSULATED COPPER GROUND WIRE

#6 AWG STRANDED INSULATED COPPER GROUND WIRE

HEREBY CERTIFY THAT THESE DRAWINGS WEF PREPARED BY ME OR UNDER MY DIRECT SUPFRVISION AND CONTROL, AND TO THE BES OF MY KNOWLEDGE AND BELIEF COMPLY WITH THE REQUIREMENTS OF ALL APPLICABLE CODES

I hereby certify that this plan, specification, or report was prepared by me or under my direct supervision and that I am a duly Licensed Professional Engineer under the laws of the State of Minnesota

Henry M. Bellagamba License # 43012

SITE NAME

CRAN_RUMW_MOAMN_008/ CRAN_RUMW_MOAMN_009/ CRAN_RUMW_MOAMN_010/ CRAN_RUMW_MOAMN_011

PACE NUMBER:

MRIMW017659/MRUMW017662 MRUMW017666/MRUMW017671

SITE ADDRESS

3200 E 81ST STREET BLOOMINGTON, MN 55425

SHEET NAME

EQUIPMENT DETAILS

SHEET NUMBER

