


Corridors of Commerce project scheduled for 2022-2024 along I-494 preliminary plans show modifications to Clover Drive & Dupont Ave.

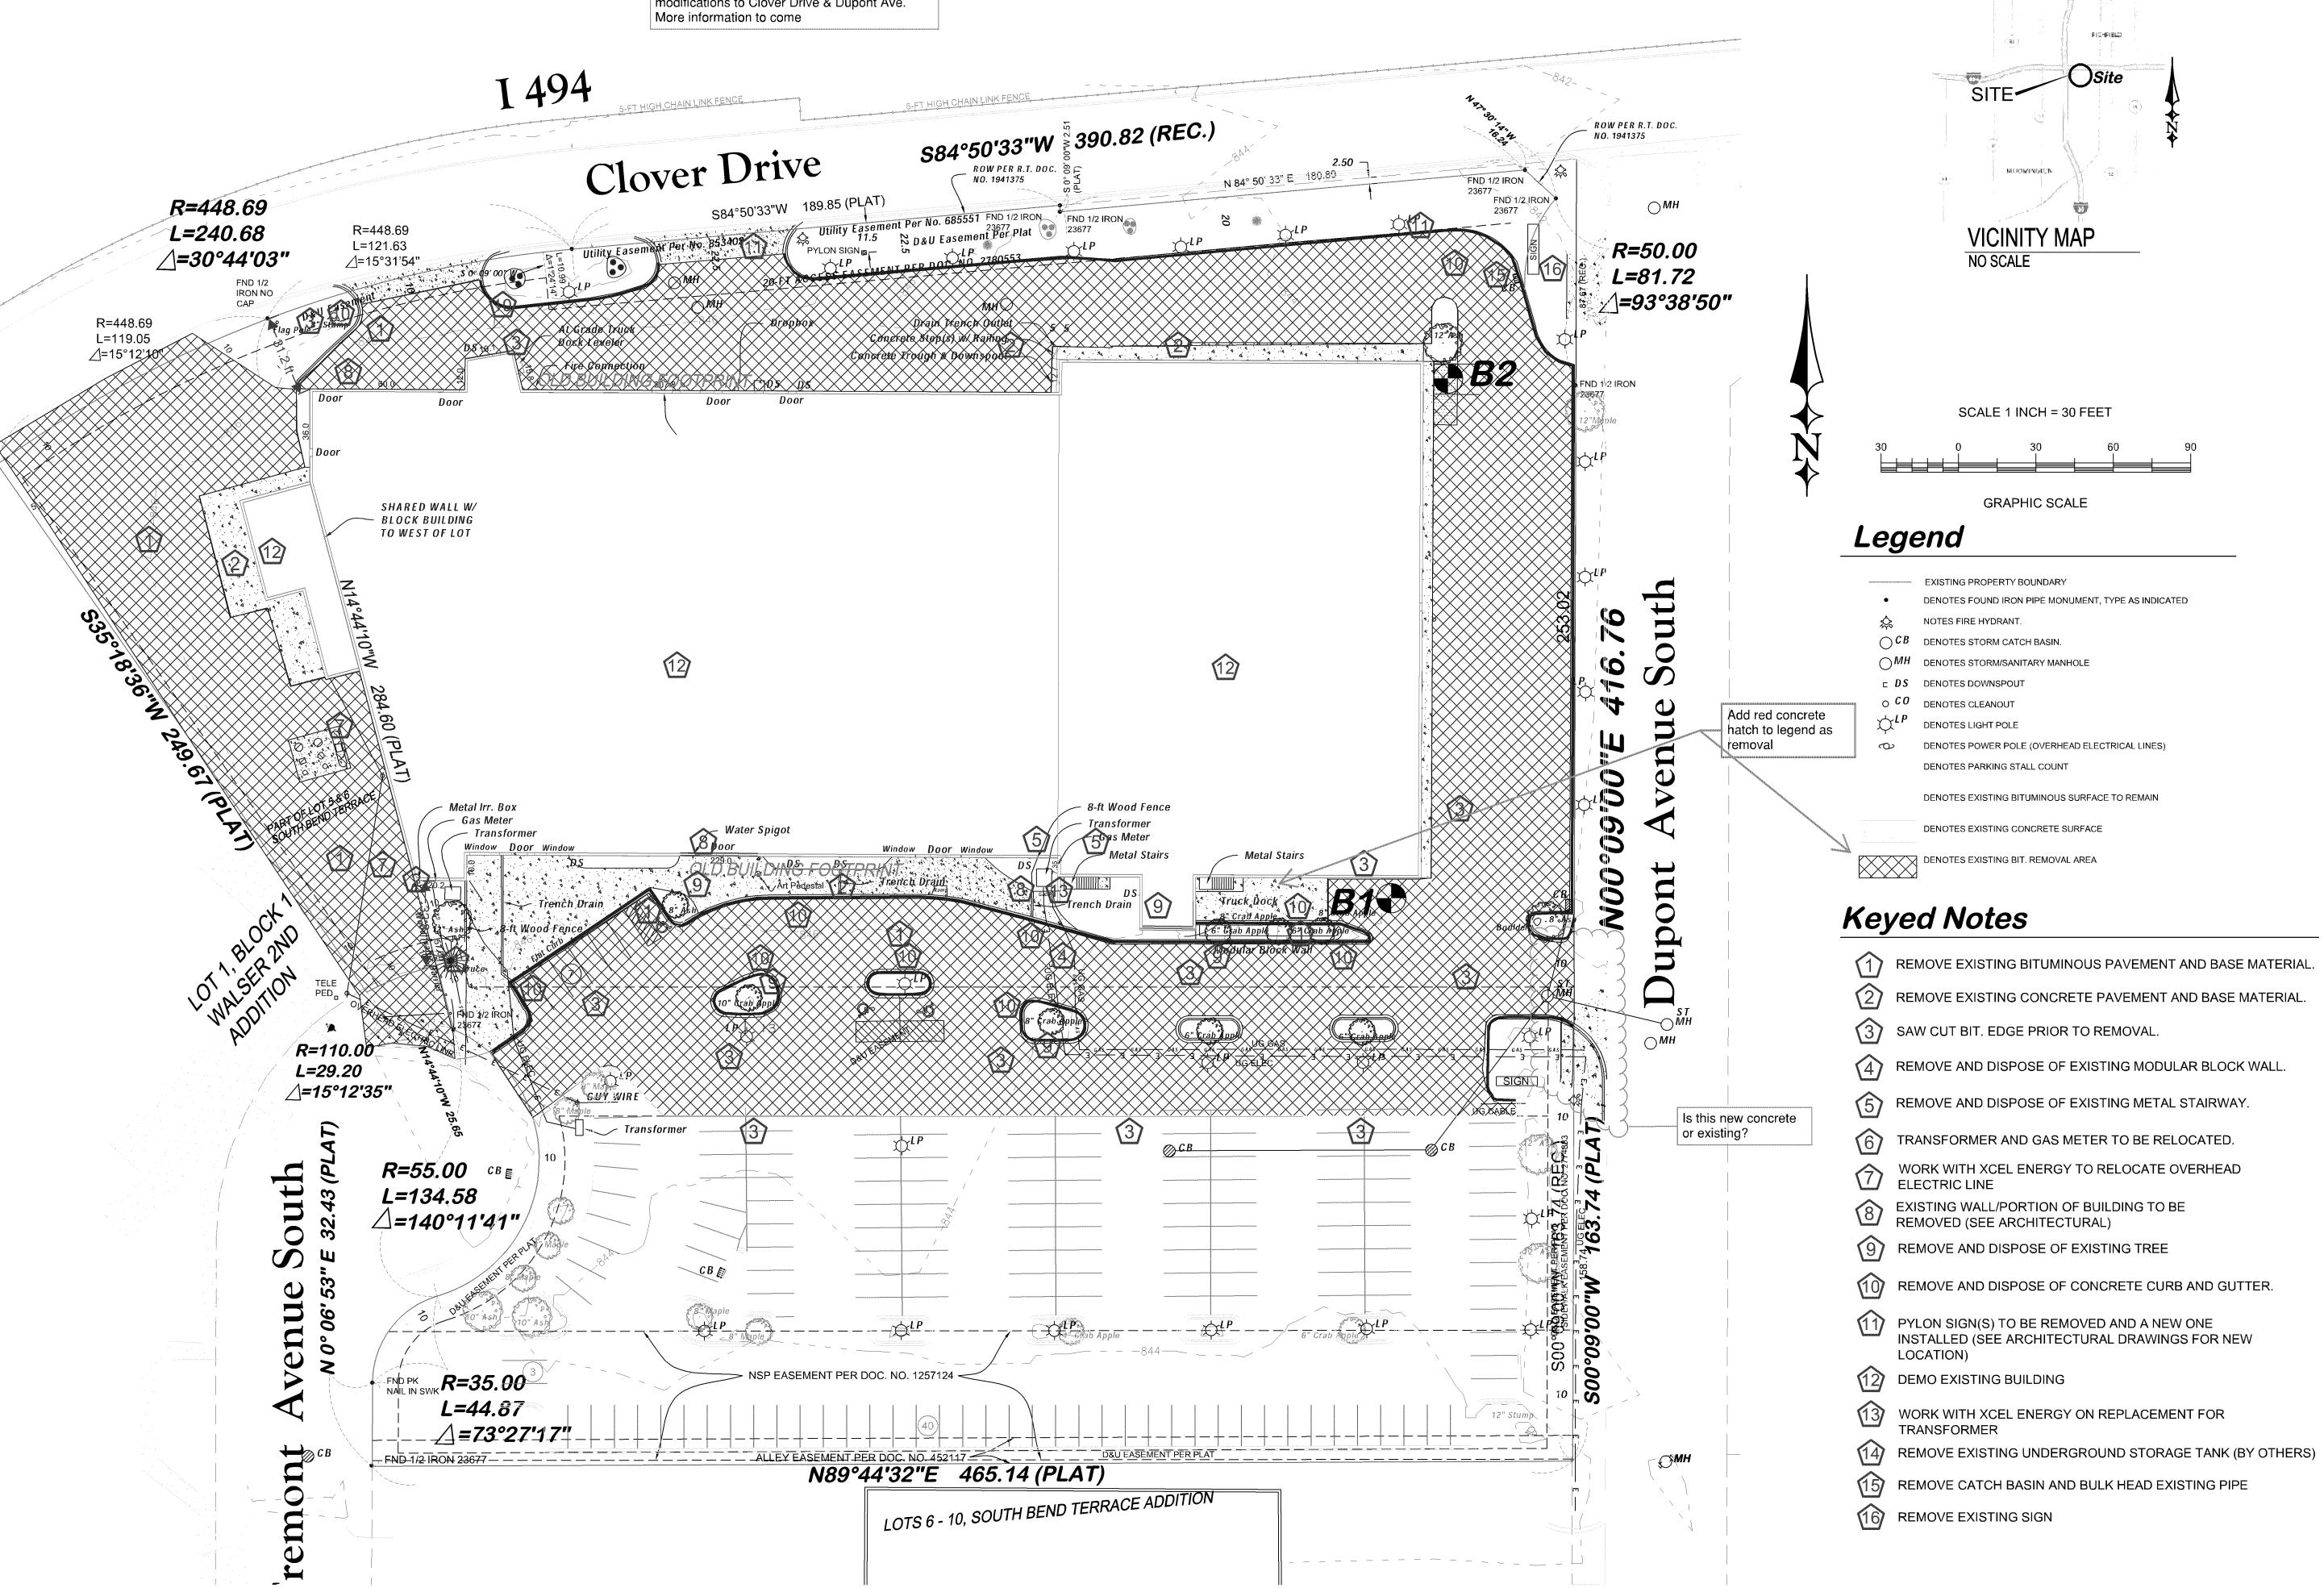

ERICKSON Civil

> 333 North Main Street, Suite 20 Stillwater, Minnesota 55082 Phone (612) 309-3804

www.ericksoncivilsite.com

**DRAWING PHASE:** OWNER REVIEW AGENCY REVIEW BID DOCUMENT

FOR CONSTRUCTION

AS-BUILT DOCUMENT

HEREBY CERTIFY THAT THIS PLAN, SPECIFICATION OR REPORT WAS PREPARED BY ME OR UNDER MY DIRECT SUPERVISION AND THAT I AM A DULY LICENSED PROFESSIONAL ENGINEER UNDER THE LAWS OF TODD A. ERICKSON, PE 40418

LICENSE NO.

07/17/2018

DATE:


HOM FURNIT 7800 Dupont Aven Bloomington, Mir

JOB NO. 15-123

SHEET TITLE EXISTING **CONDITIONS &** DEMO PLAN


SHEET NO.

SHEET 1 OF 6

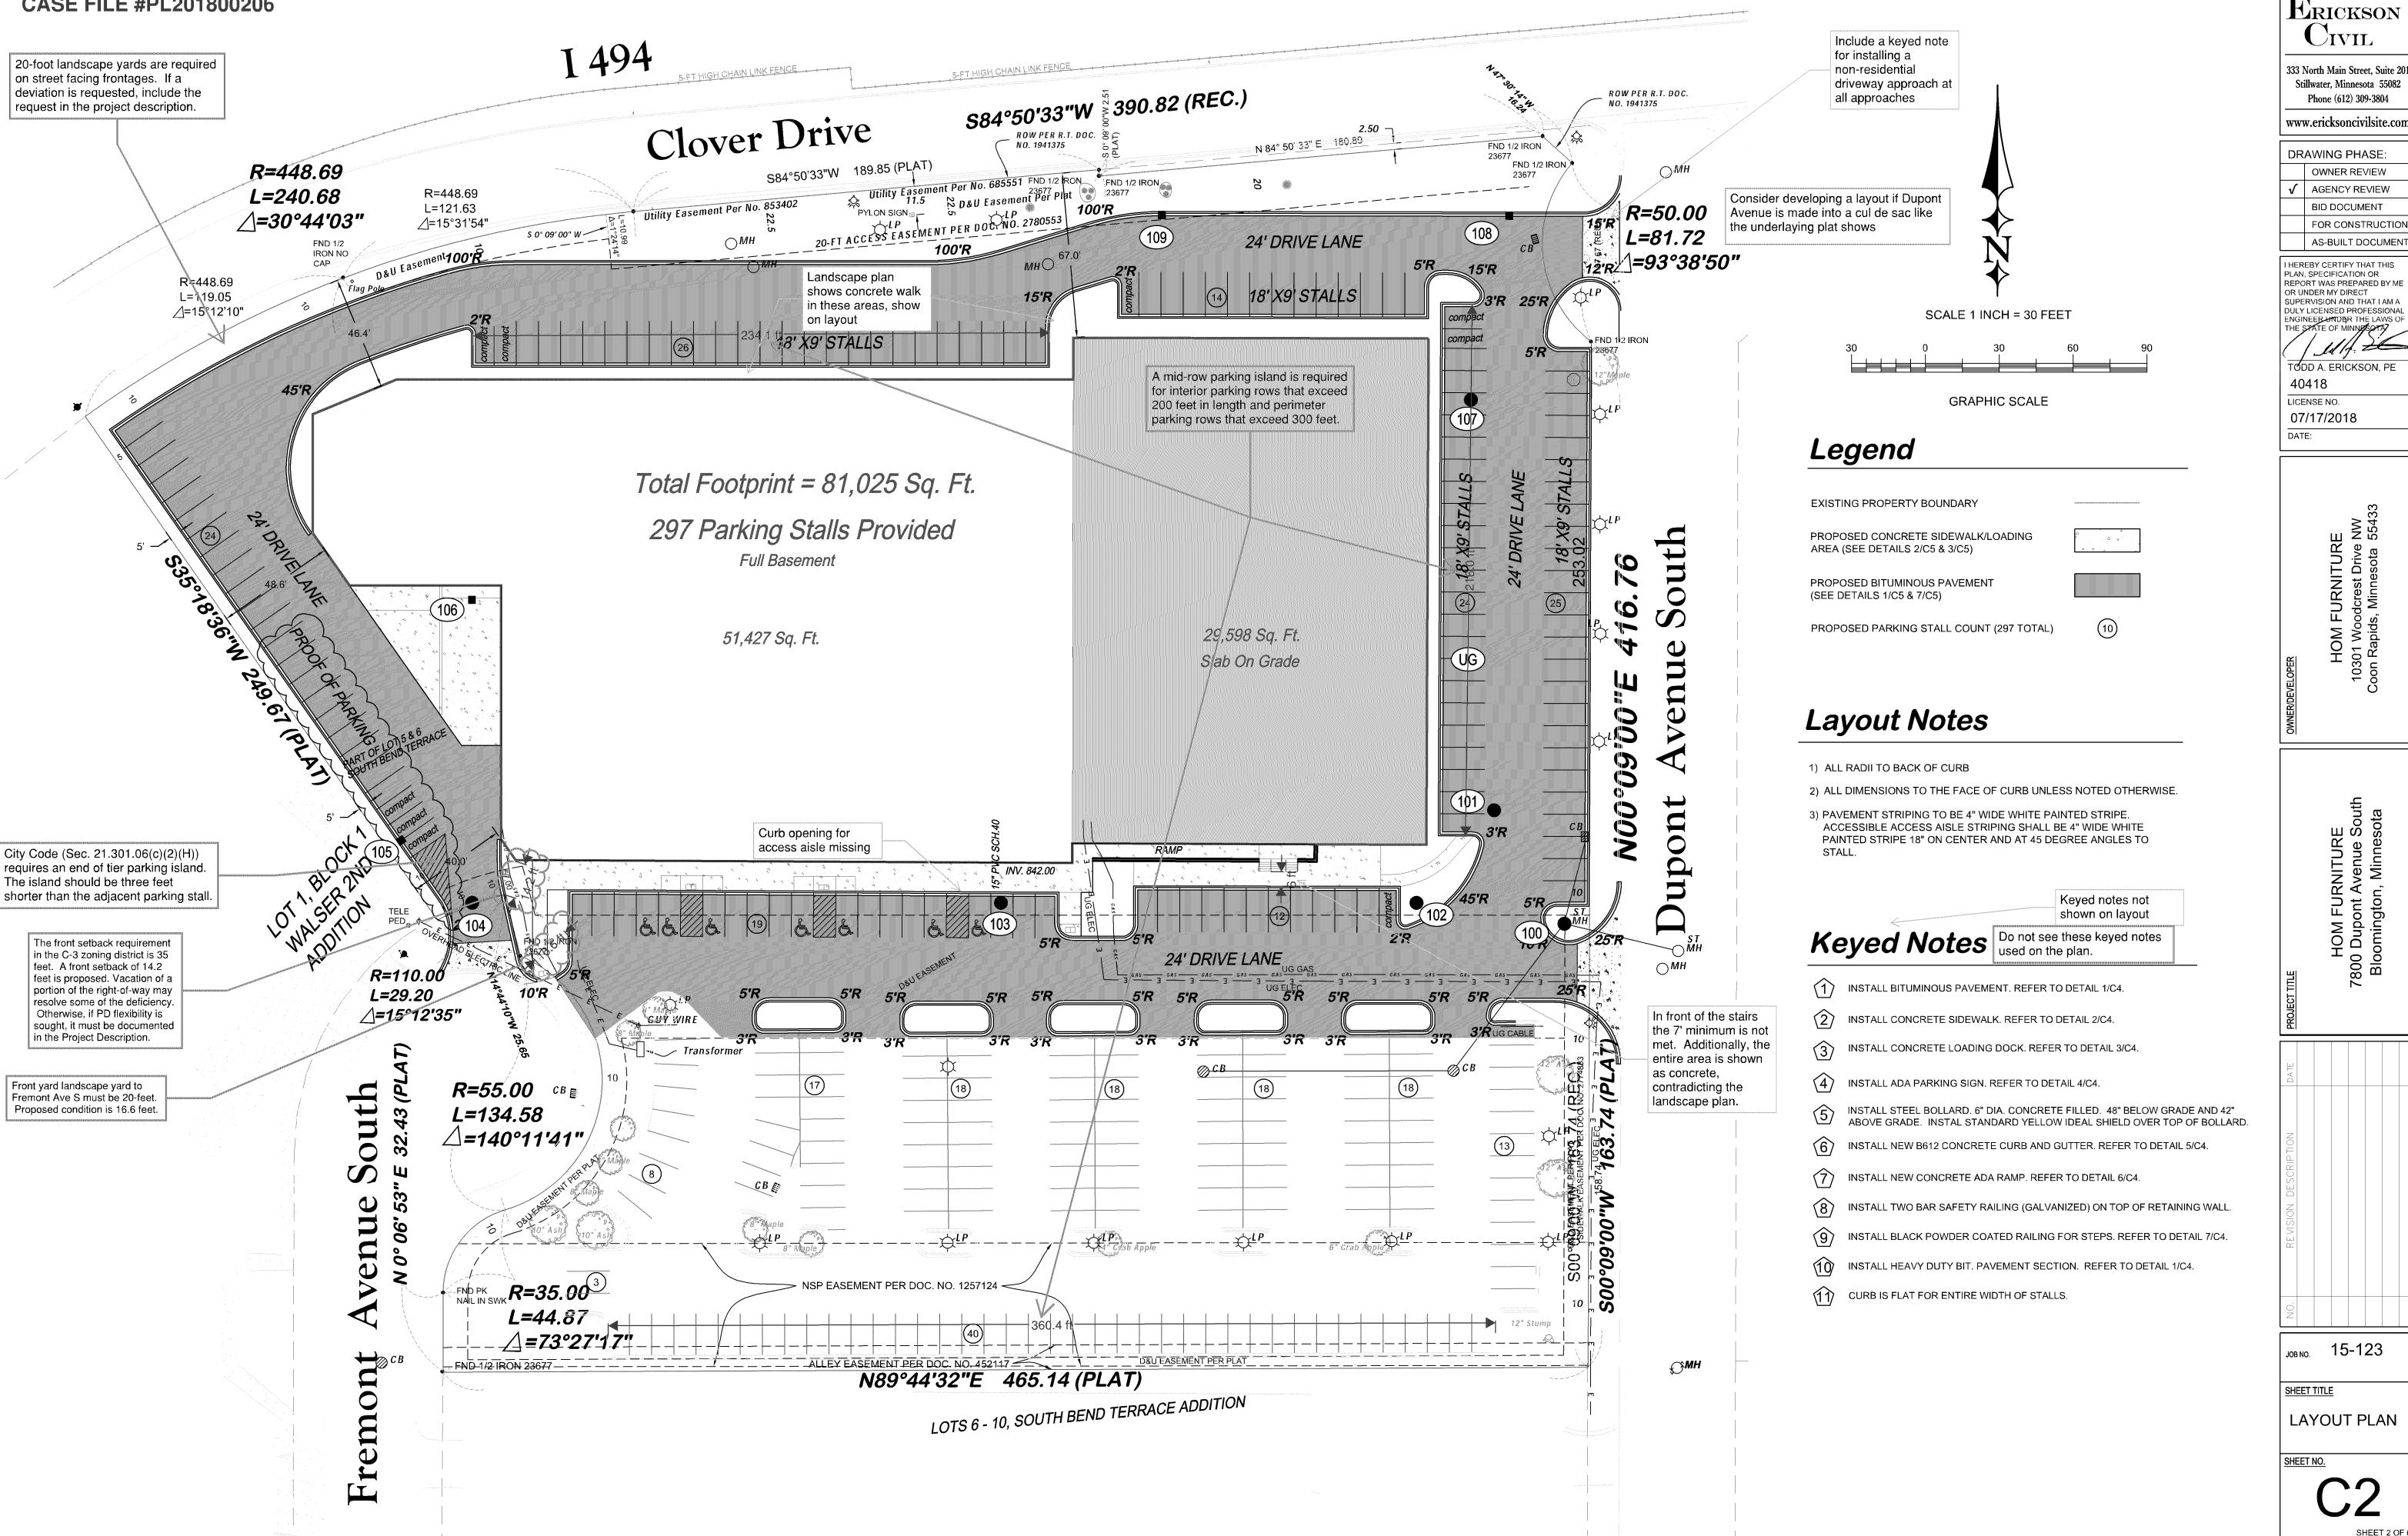

ERICKSON

FOR CONSTRUCTION AS-BUILT DOCUMENT

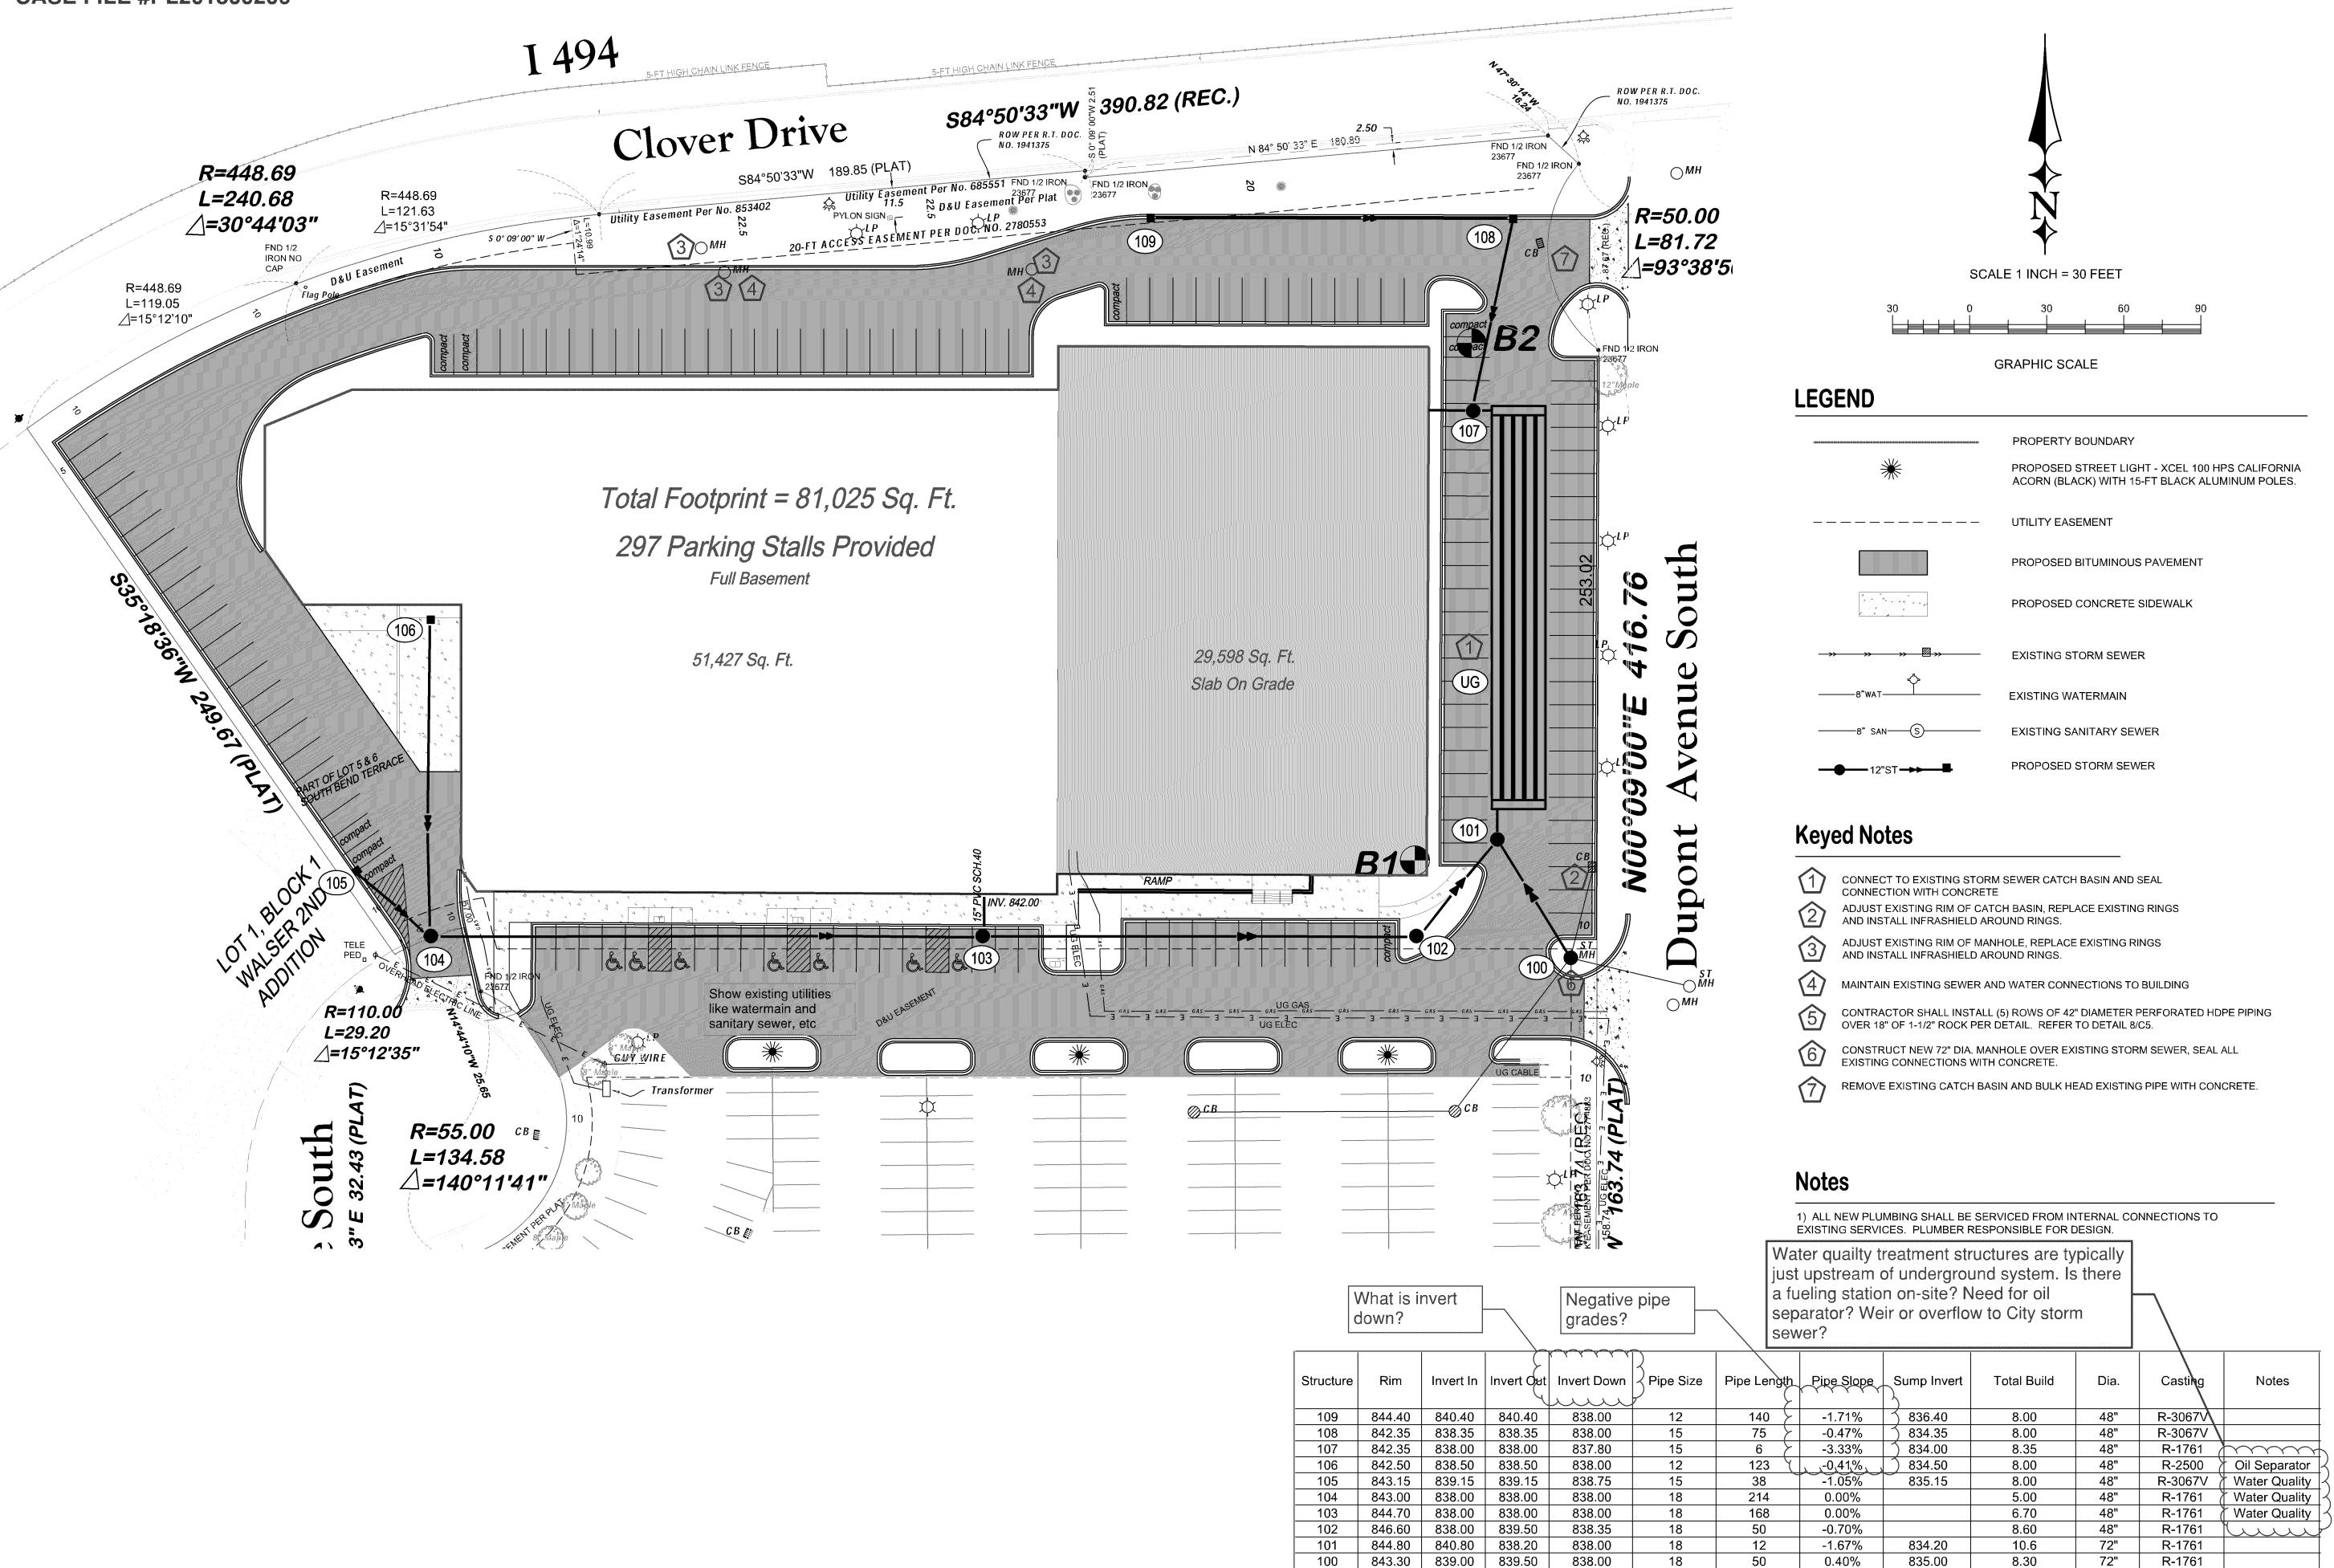

835.00 835.00

Erickson Civil

333 North Main Street, Suite 20 Stillwater, Minnesota 55082 Phone (612) 309-3804

www.ericksoncivilsite.com

DRAWING PHASE:

OWNER REVIEW

✓ AGENCY REVIEW

BID DOCUMENT

FOR CONSTRUCTION

AS-BUILT DOCUMENT

I HEREBY CERTIFY THAT THIS PLAN, SPECIFICATION OR REPORT WAS PREPARED BY ME

PLAN, SPECIFICATION OR
REPORT WAS PREPARED BY ME
OR UNDER MY DIRECT
SUPERVISION AND THAT I AM A
DULY LICENSED PROFESSIONAL
ENGINEER UNDER THE LAWS OF

TODD A. ERICKSON, PE
40418
LICENSE NO.
07/17/2018

07/17/2018
DATE:

HOM FURNITURE 10301 Woodcrest Drive NW Soon Rapids, Minnesota 55433

HOM FURNITURE 7800 Dupont Avenue South Bloomington, Minnesota

REVISION DESCRIPTION DATE

<sub>ЈОВ NО.</sub> 15-123


SHEET TITLE

UTILITY PLAN

SHEET NO.


Volume Control

**5** SHEET 4 OF

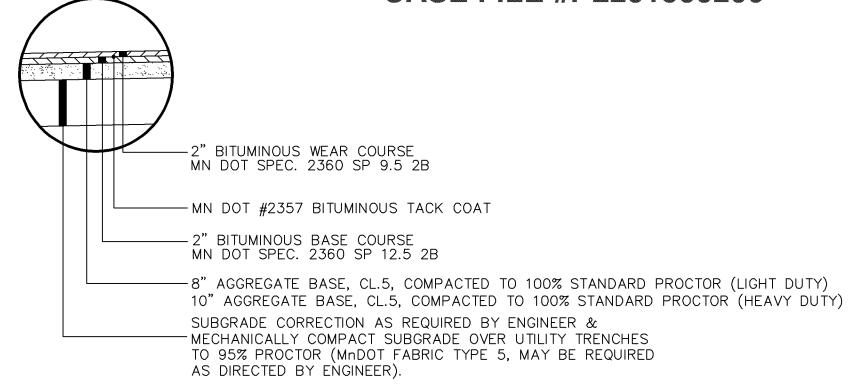

## BITUMINOUS PAVING SECTION(S)

C5NO SCALE

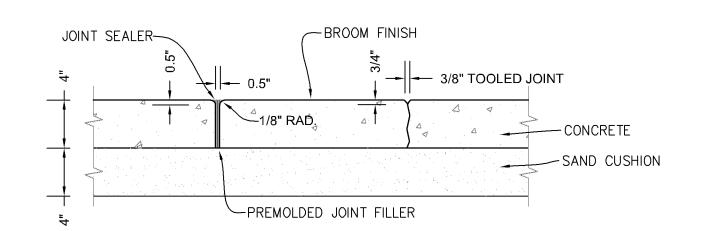

## CONCRETE SIDEWALK DETAIL

C5 NO SCALE

NOTES: TOOLED JOINTS:

1) JOINT SPACING SHALL MATCH WALK WIDTH UNLESS SHOWN OTHERWISE ON PLANS.


**EXPANSION JOINTS:** 

- 1) WHERE WALK BUTTS ANY FIXED OBJECT SUCH AS WALLS.
- CURBS, MANHOLES, ETC.
- 2) 45' ON CENTER MAXIMUM OR AS SHOWN ON PLANS. 3) JOINT SEALER SHALL MEET ASTM D-412, GRAY, SELF
- LEVELING,

EPOXY, AS WITH "QUICKJOINT 300" OR EQUAL


2"X18" (R7-128) HANDICAPPED **ALUMINUM SIGN** 12"X6" (R7-8ab) VAN ACCESSIBLE **ALUMINUM SIGN** - 2.5 LB./FT FLANGED **CHANNEL SIGN POST** (MNDOT 3401) - 4" SCH. 40 STEEL PIPE FILL WITH CONC. PAINTED TRAFFIC YELLOW - 3500 PSI CONCRETE

**ADA SIGN AND POST** C5 / NO SCALE

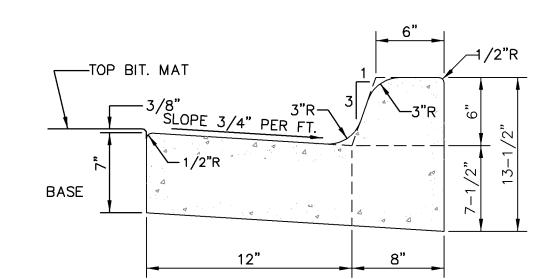



5 B612 CURB & GUTTER C5 NO SCALE

> Provide detail for manholes and sump structures

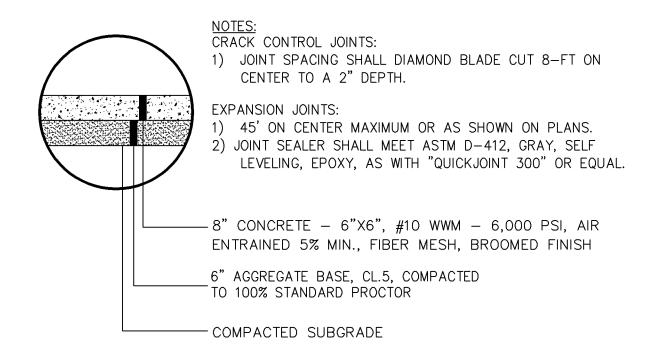

CONCRETE DOCK SECTION C5 NO SCALE

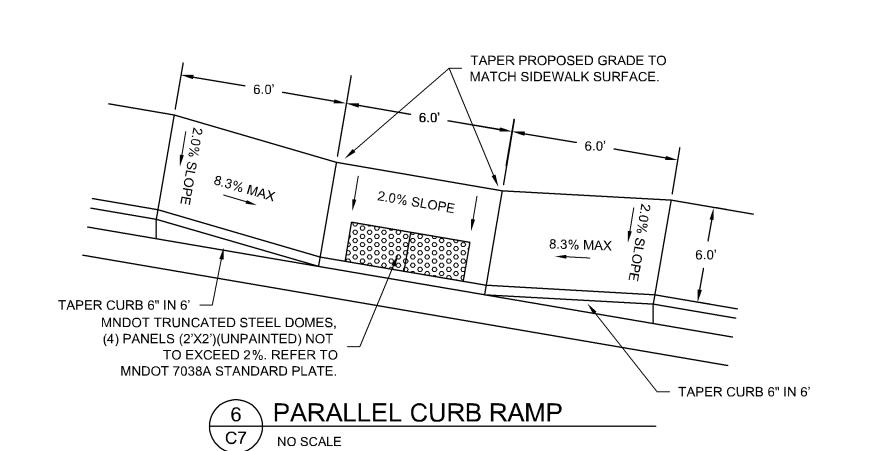

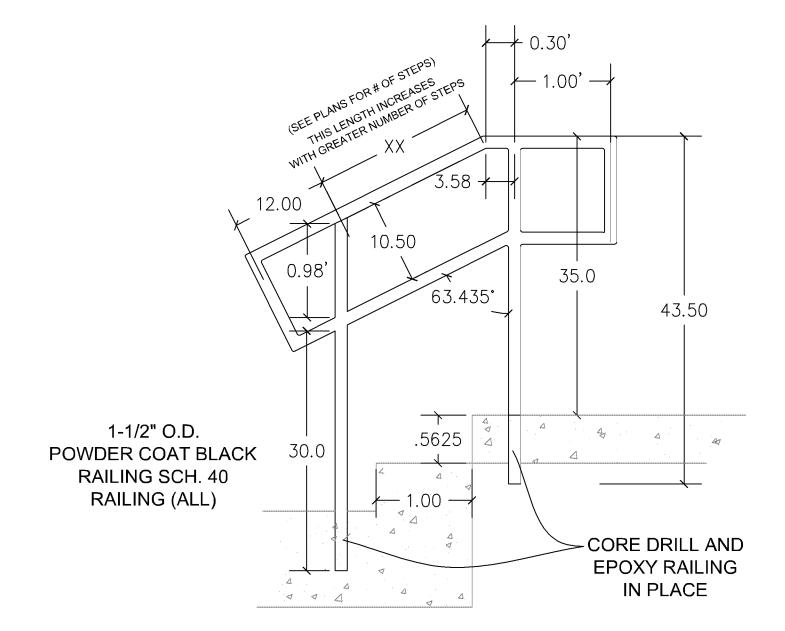


## TYPICAL EXTERIOR RAILING DETAIL

C5 NO SCALE

Per Safety Rail Company: 4244 Shoreline Drive, Spring Park, MN 55384 Phone: 888-434-2720 | Fax: 888-471-4931 www.safetyrailcompany.com

Provide details for underground system:

- 'pipe materials and fittings, what is "end run"?
- ' pipe lengths, rock area
- rock materials (ASTM reference is not widely known or readily available on-line, no crushed concrete or limestone)
- \* what geotextile is to be used and where
- pipe spacing, looks to narrow in detail, should be D/2?
- Underground system shall be as-built and certified by a Professional Engineer

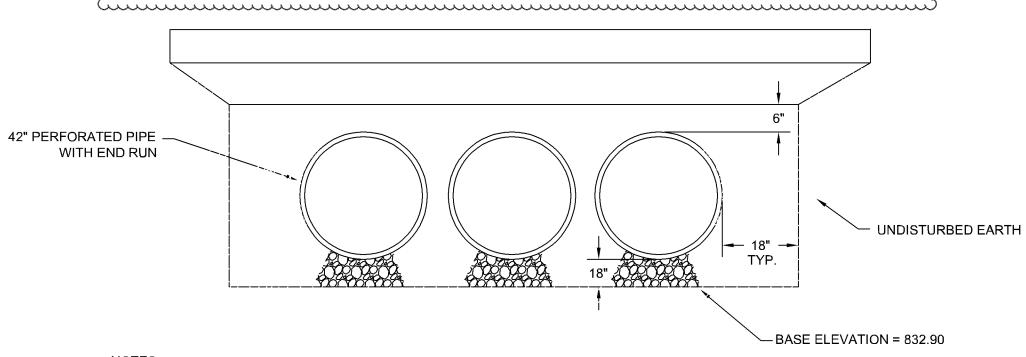

NOTES:

- 1. ALL REFERENCES TO CLASS I OR II MATERIAL ARE PER ASTM D2321 "STANDARD PRACTICE FOR UNDERGROUND INSTALLATION OF THERMOPLASTIC PIPE FOR SEWERS AND OTHER GRAVITY FLOW APPLICATIONS", LATEST EDITION.
- 2. ALL RETENTION AND DETENTION SYSTEMS SHALL BE INSTALLED IN ACCORDANCE WITH ASTM D2321, LATEST EDITION AND THE MANUFACTURER'S PUBLISHED INSTALLATION GUIDELINES.
- 3. MEASURES SHOULD BE TAKEN TO PREVENT THE MIGRATION OF NATIVE FINES INTO THE BACKFILL MATERIAL, WHEN REQUIRED. SEE ASTM D2321.
- 4. FILTER FABRIC: A GEOTEXTILE FABRIC MAY BE USED AS SPECIFIED BY THE ENGINEER TO PREVENT THE MIGRATION OF FINES FROM THE NATIVE SOIL INTO THE SELECTED BACKFILL MATERIAL.
- 5. FOUNDATIONS: WHERE THE TRENCH BOTTOM IS UNSTABLE, THE CONTRACTOR SHALL EXCAVATE TO A DEPTH REQUIRED BY THE ENGINEER AND REPLACE WITH SUITABLE MATERIAL AS SPECIFIED BY THE ENGINEER. AS AN ALTERNATIVE AND AT THE DISCRETION OF THE DESIGN ENGINEER, THE TRENCH BOTTOM MAY BE STABILIZED USING A GEOTEXTILE MATERIAL.
- 6. BEDDING: SUITABLE MATERIAL SHALL BE CLASS I AND II. THE CONTRACTOR SHALL PROVIDE DOCUMENTATION FOR MATERIAL SPECIFICATION TO ENGINEER.
- 7. INITIAL BACKFILL: SUITABLE MATERIAL SHALL BE CLASS I OR II IN THE PIPE ZONE EXTENDING NOT LESS THAN 6" ABOVE CROWN OF PIPE. THE CONTRACTOR SHALL PROVIDE DOCUMENTATION FOR MATERIAL SPECIFICATION TO ENGINEER. MATERIAL SHALL BE INSTALLED AS REQUIRED IN ASTM D2321, LATEST EDITION.



ERICKSON Civil

333 North Main Street, Suite 20 Stillwater, Minnesota 55082 Phone (612) 309-3804

www.ericksoncivilsite.com

**DRAWING PHASE:** OWNER REVIEW AGENCY REVIEW

BID DOCUMENT FOR CONSTRUCTION AS-BUILT DOCUMENT

HEREBY CERTIFY THAT THIS PLAN, SPECIFICATION OR REPORT WAS PREPARED BY ME OR UNDER MY DIRECT SUPERVISION AND THAT I AM A **DULY LICENSED PROFESSIONAL** THE STATE OF MINNESOTA?

TODD A. ERICKSON, PE 40418

LICENSE NO. 07/17/2018

DATE:


HOM FURNIT 7800 Dupont Aven Bloomington, Mir

JOB NO. 15-123

SHEET TITLE


DETAILS

SHEET NO.

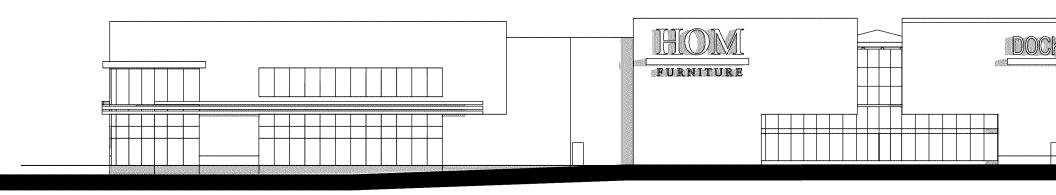


#### NORTH ELEVATION SCALE: 1"=30'

Signs on the north and south elevations are limited to individual letters not to exceed the allocation or a total of 1 wall should a cabinet sign be used. The lines below the signs and the "86" circle is considered a cabinet. Code allo part of the individual letters not to exceed 25 percent of the sign. The signs as shown would not comply with the Coaddition, some signs are shown above the roof line on the updated elevations and is prohibited by City

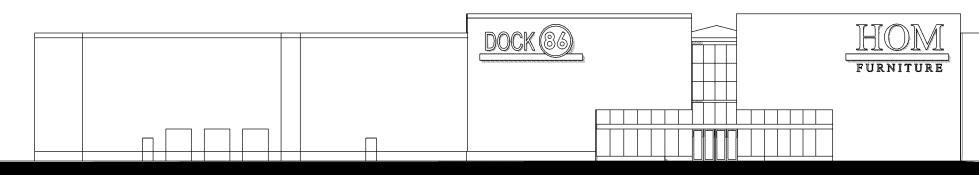

#### SOUTH ELEVATION SCALE: 1"=30"

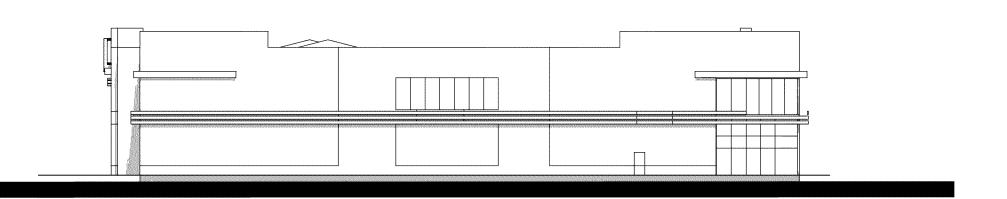



EAST ELEVATION SCALE: 1"=30'


DRAFT FURNITURE RETAIL - SUBJECT TO CHANGE BLOOMINGTON, MN


Provide a code analysis with the plans.

S/ red

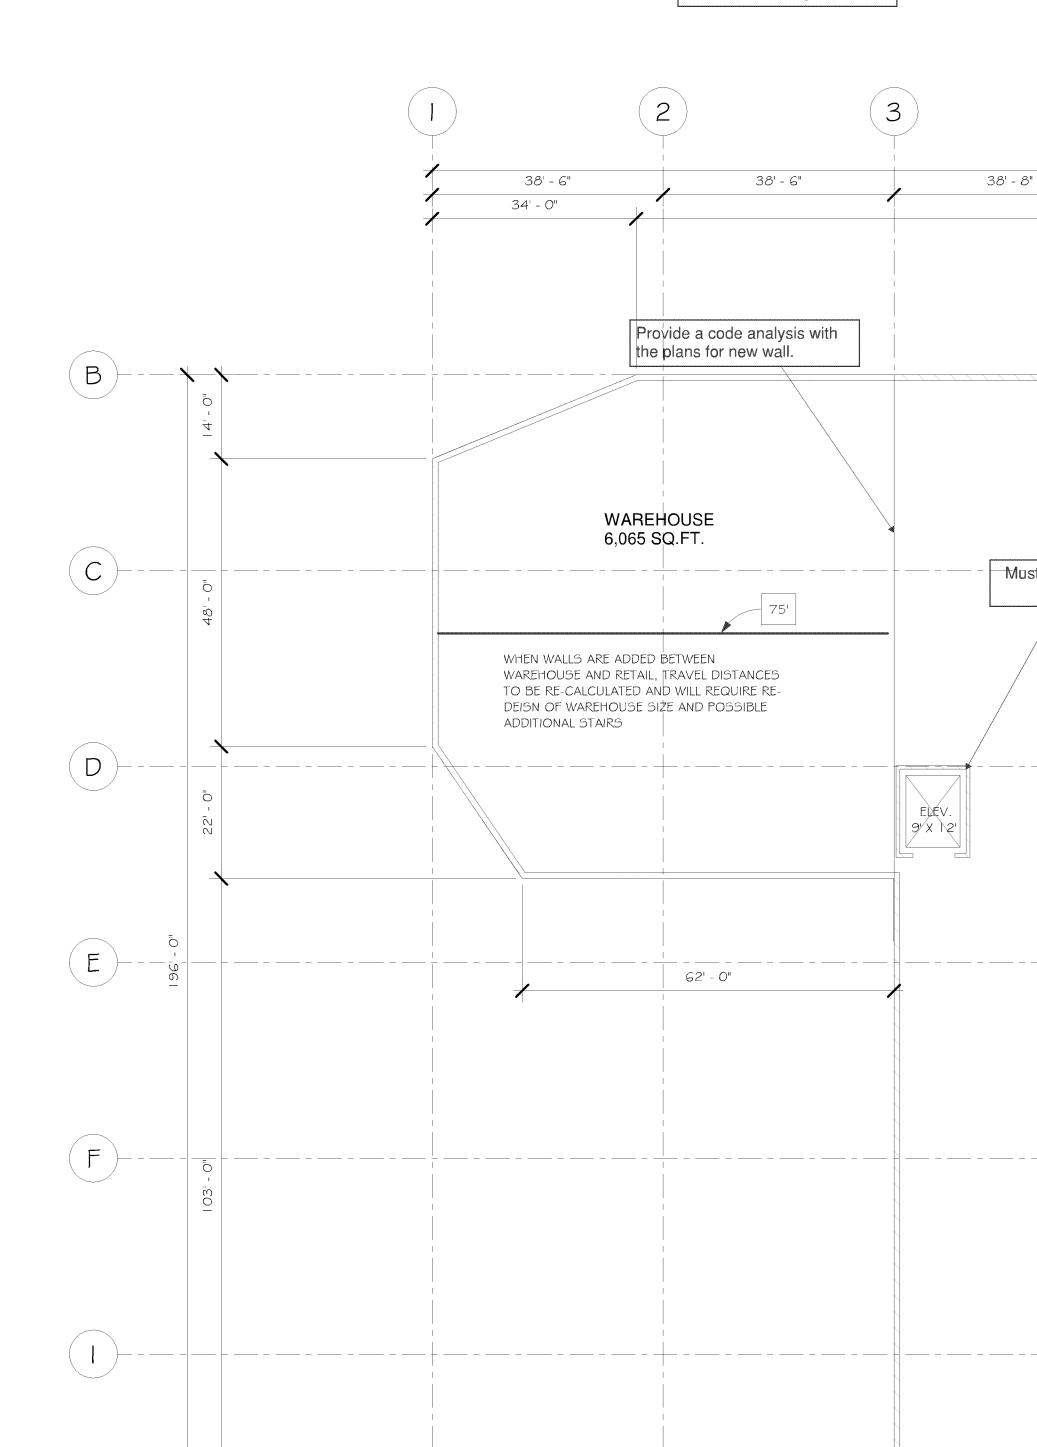

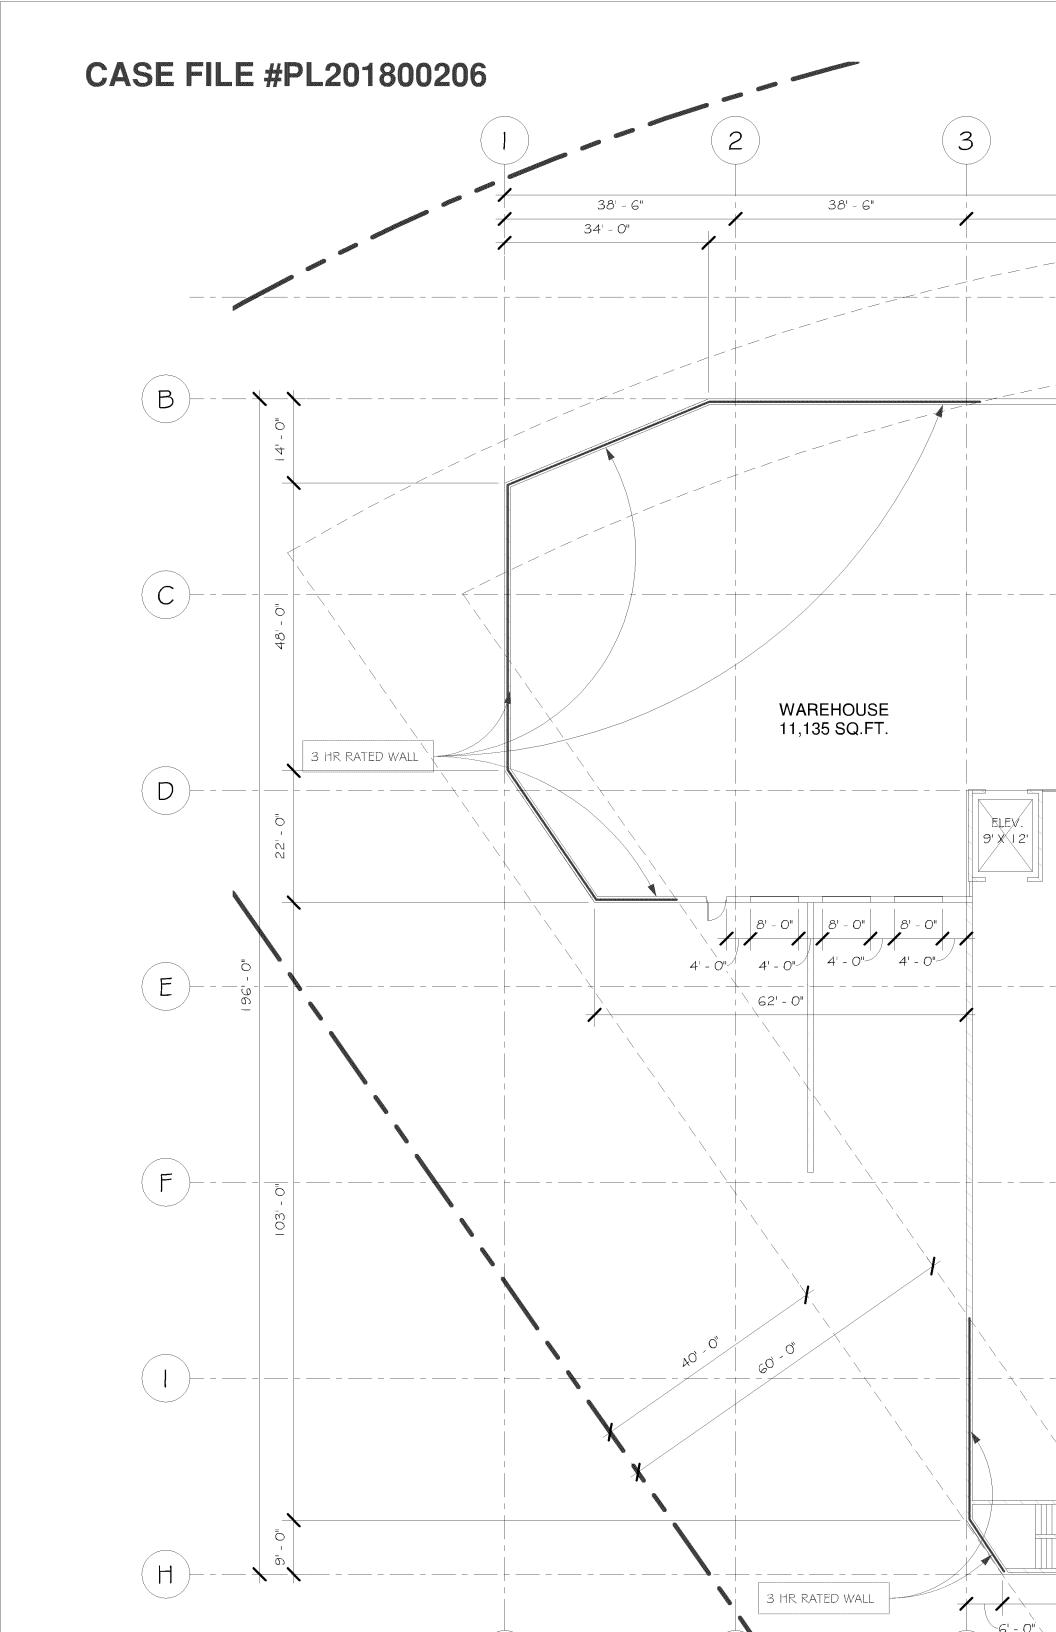

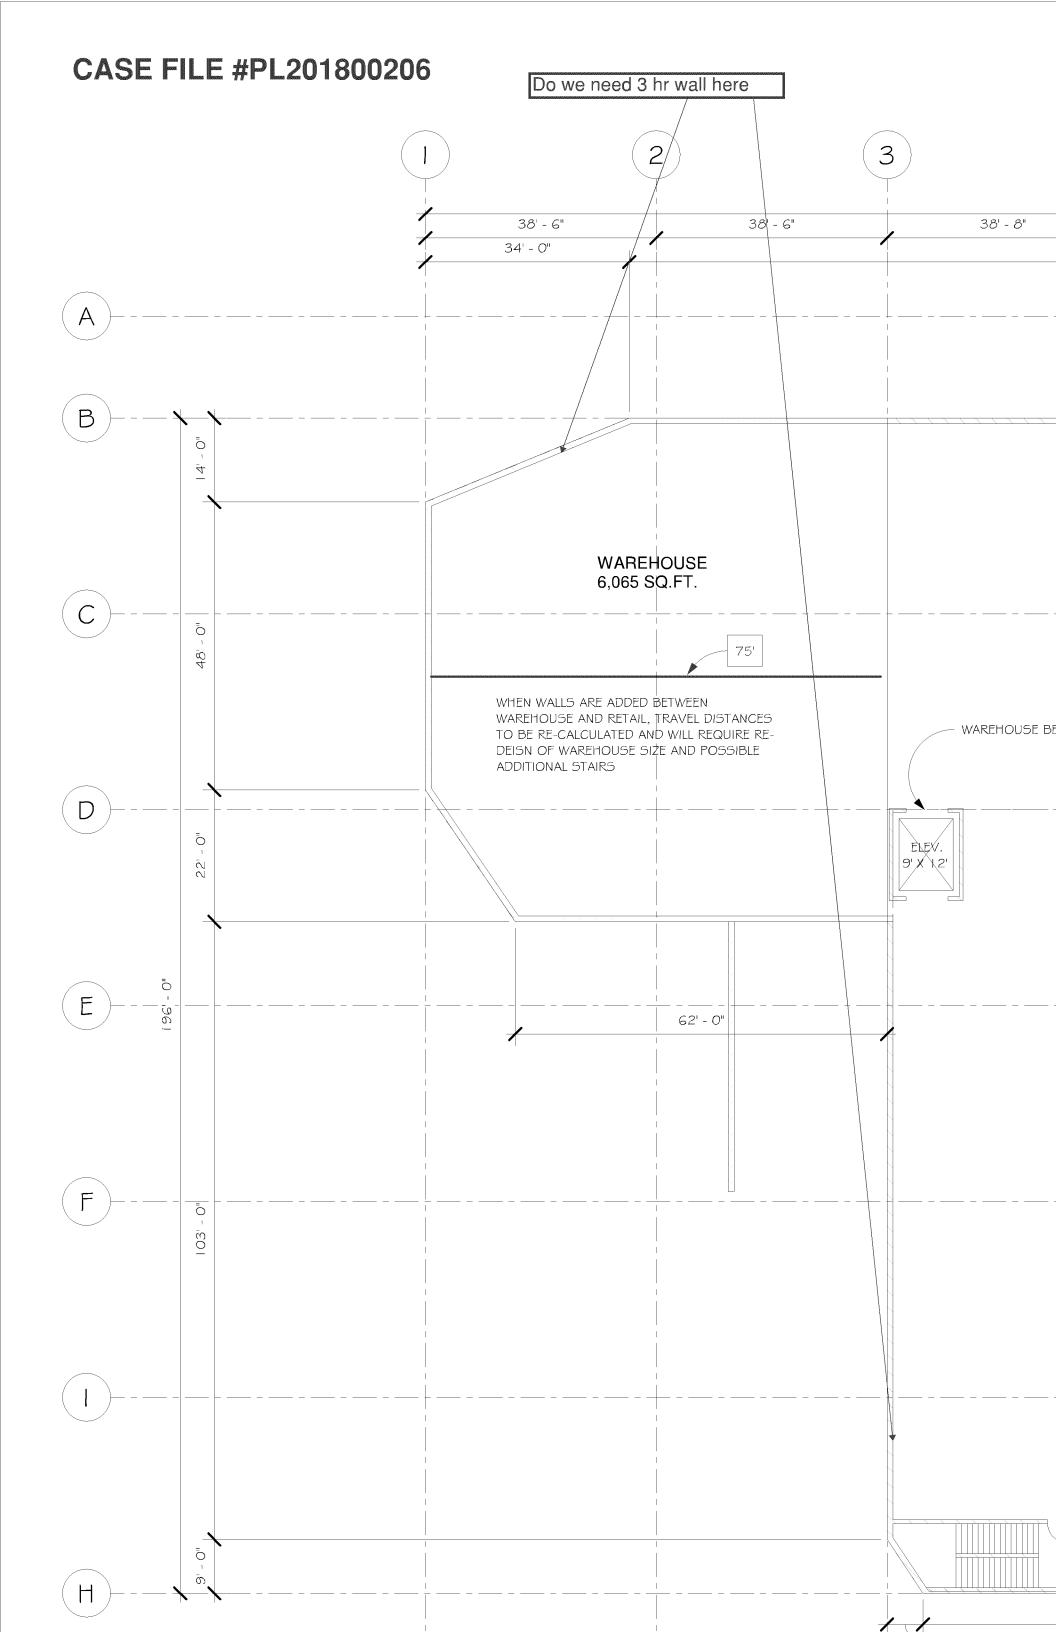

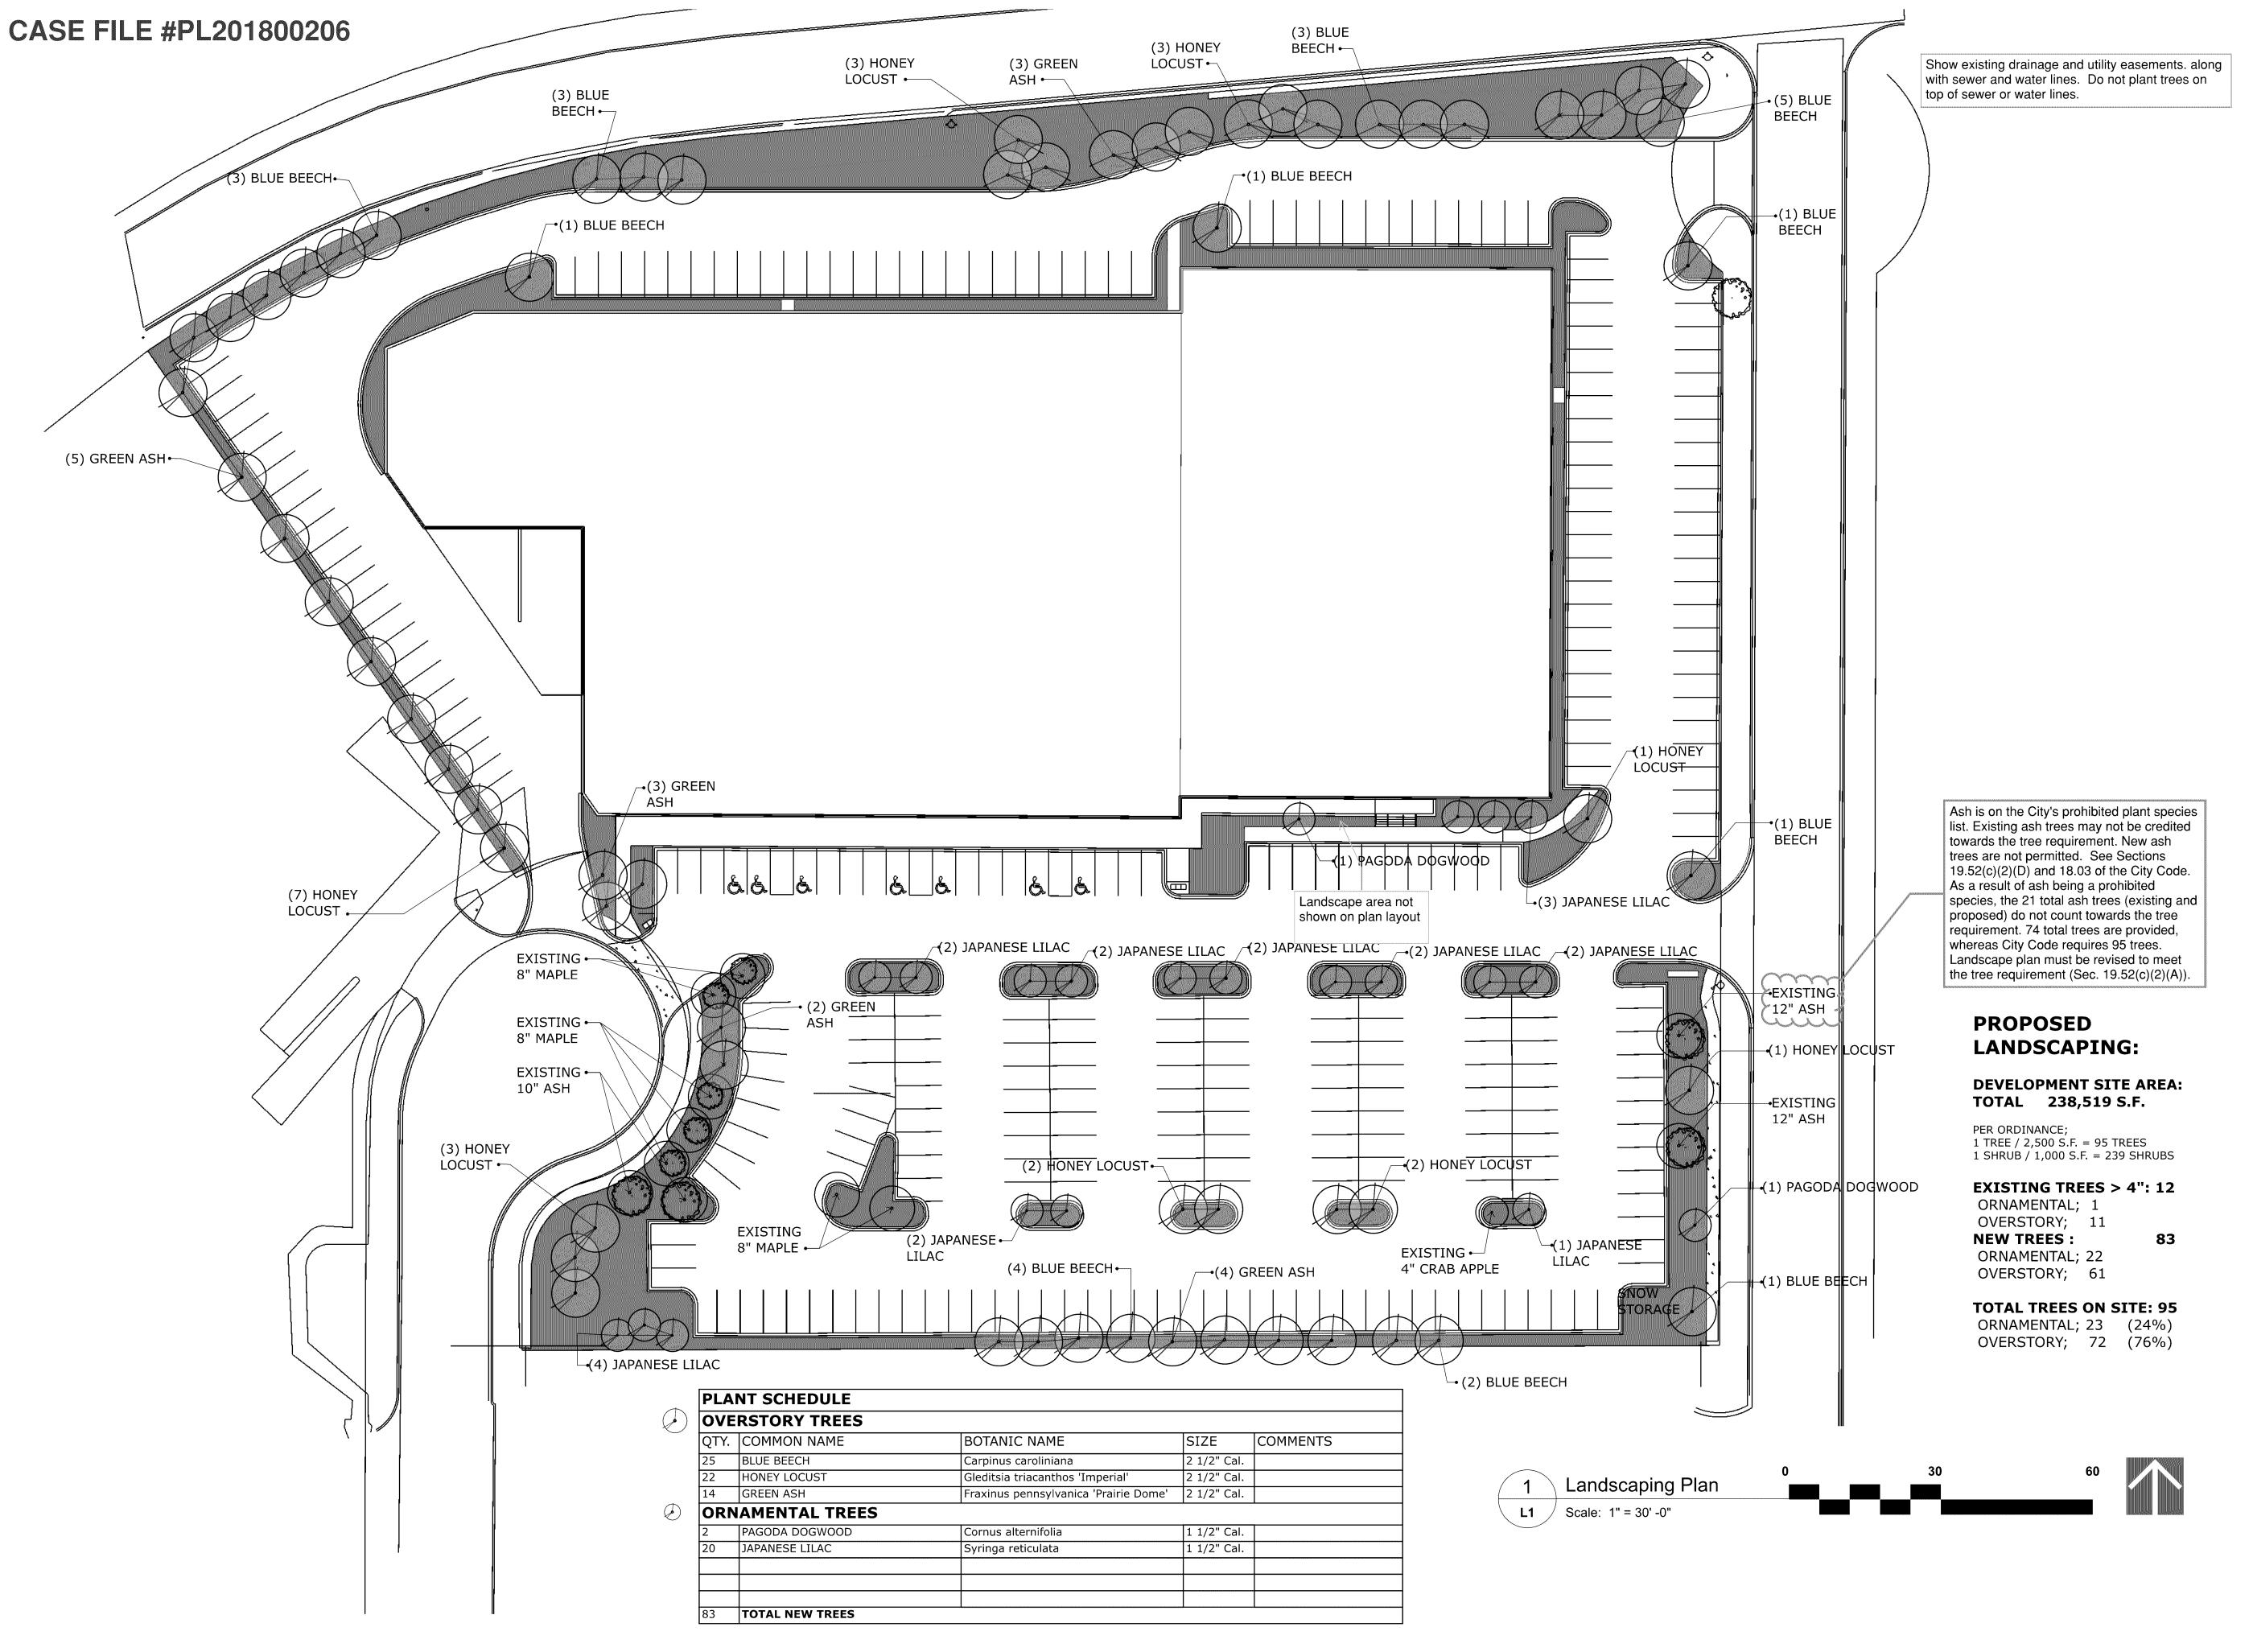



S

architecture • interiors sustainable design

333 N Main St. Ste. 201 Stillwater, MN 55082 651-430-0606 archnetusa.com

## HOM Furniture

7800 Dupont Ave. S. Bloomington, Minnesota

Revisions	
Item	Date

#### Registration Information

I hereby certify that this plan, specification, or report was prepared by me or under my direct supervision, and that I am a duly Licensed Architect under the laws of the State of Minnesota

DATE License #


Sheet Information
SITE LANDSCAPING PLAN
TREES


Project No: 15-107 Drawing No:

Drawn By: RLT
Checked By:

Date: 7-17-18

©2018 ARCHNET, Inc.

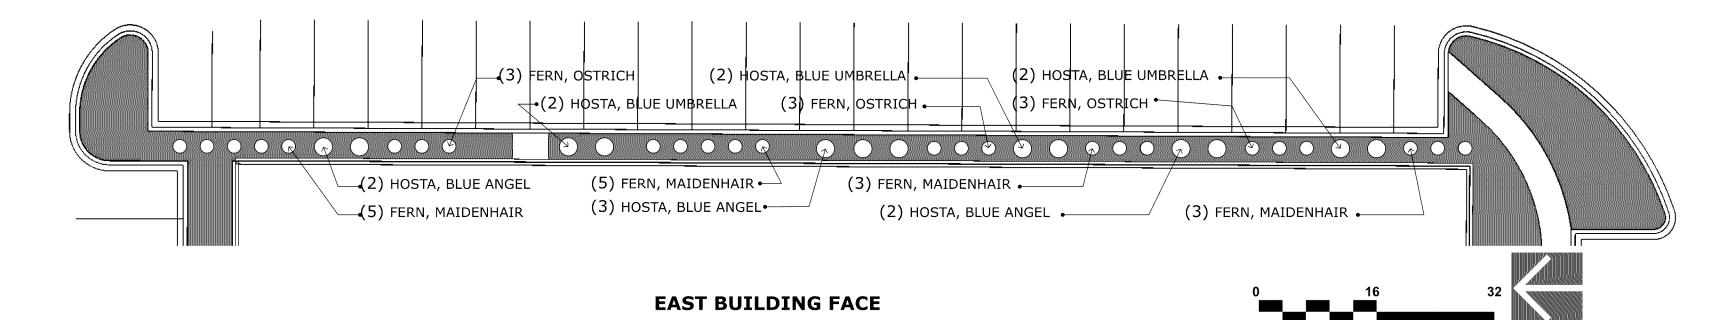

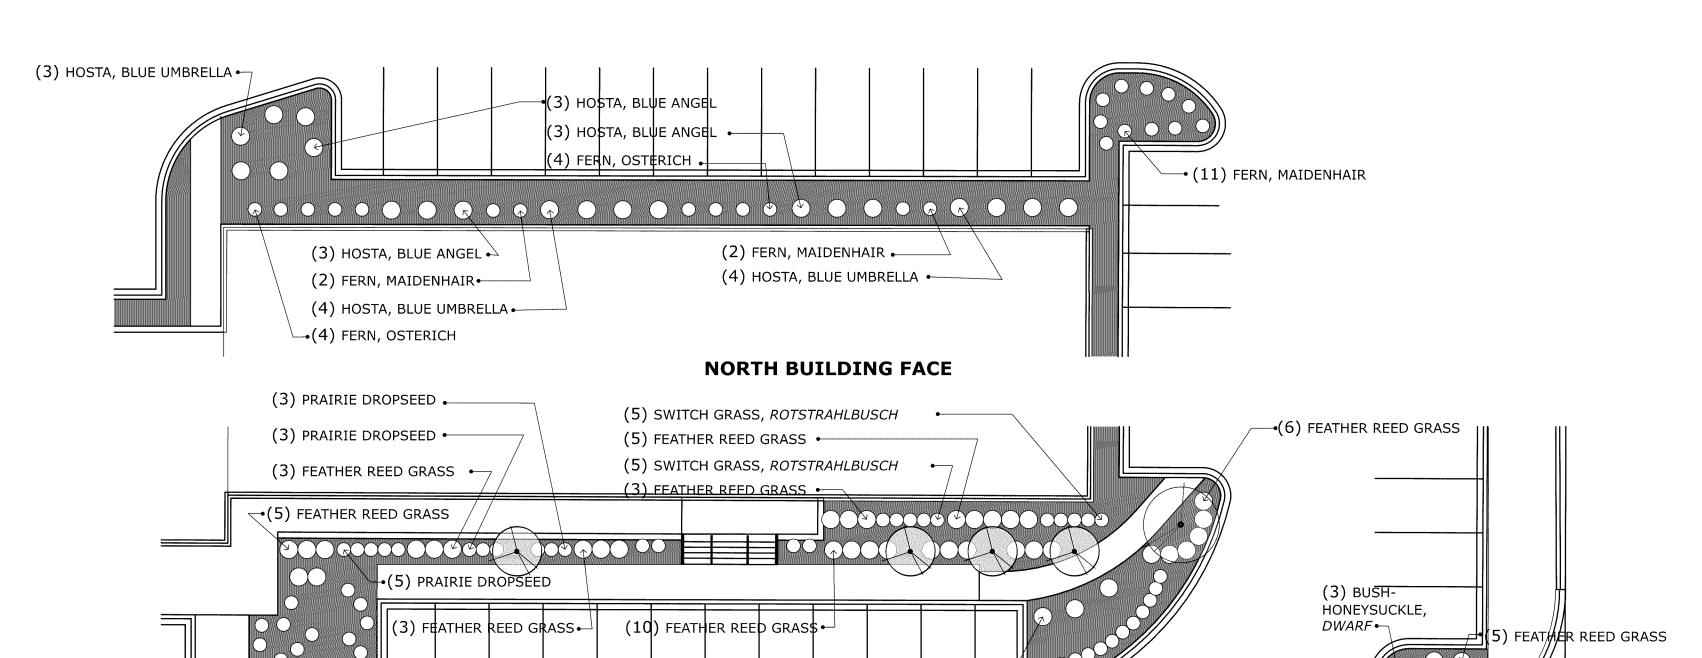

SOUTH BUILDING FACE


0 16 32

**SOUTH WEST BUILDING CORNER** 

The site is required to have 239 shrubs. Switch grass, prairie dropseed, feather reed grass, ferns and hostas are perennials. Per Section 19.52(c)(2)(B) of the City Code, four perennial plants equal one shrub. As a result, 89 shrub equivalent units are provided. Up to 50% of the shrub requirement may be perennial plants. Landscape plan must be revised to provide the required amount of shrubs.

SHR	SHRUBS / PERENNIALS			
QTY.	COMMON NAME	BOTANIC NAME	SIZE	COMMENTS
14	SWITCH GRASS, ROTSTRAHLBUSCH	P. virgatum 'northwinds'	#1 Cont.	
45	PRAIRIE DROPSEED	Sporobolus heterolepis 'Tara'	#1 Cont.	
59	FEATHER REED GRASS	Calamagrostis 'Karl Foerster'	#1 Cont.	
22	BUSH-HONEYSUCKLE, DWARF	Diervilla lonicera	#5 Cont.	
6	FALSESPIREA	Sorbaria sorbifolia 'Sem'	#5 Cont.	
12	HYDRANGEA, ANNABELLE	Hydrangea arborsecens 'Annabelle'	#3 Cont.	
31	FERN, MAIDENHAIR	Adentum pedatum	#1 Cont.	
17	FERN, OSTRICH	Matteucia struthiopteris	#1 Cont.	
16	HOSTA, BLUE ANGEL	Hosta 'Blue Angel'	#1 Cont.	
17	HOSTA, BLUE UMBRELLA	Hosta 'Blue Umbrellas"	#1 Cont.	
239	TOTAL SHRUBS	•		

(22) PRAIRIE DROPSEED

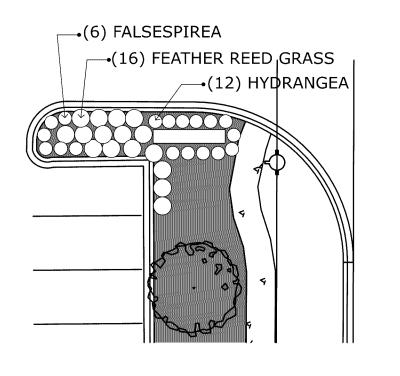

**NORTH SIDE OF** 

EAST PARKING ENTRY

0 16 32

(12) PRAIRIE DROPSEED

∠\_•(3) FEATHER REED GRASS



(4) SWITCH GRASS, ROTSTRAHLBUSCH

SOUTH SIDE OF EAST PARKING ENTRY



# HOM Furniture

7800 Dupont Ave. S. Bloomington, Minnesota

Revisions	
Item	Date

Registra I hereby certify or report was produced supervise Licensed Archi	that th repared sion, a tect ur	is plan, spe d by me or nd that I ar	ecificatio under r n a duly
DATE		Licens	e #

Sheet Information		
SITE LA		ING PLAN
	SHRUB	S
Project No:	15-107	Drawing No
Drawn By:	RLT	. ^
Checked By:		L2
Date: (	07-17-18	
©20	18 ARCHNI	ET, Inc.