

# SEAGATE BLOOMINGTON ELEVATOR ADDITION

#### **CASE FILE #PL2020-19**

# BLOOMINGTON, MINNESOTA CONSTRUCTION DOCUMENTS OCTOBER 25, 2019

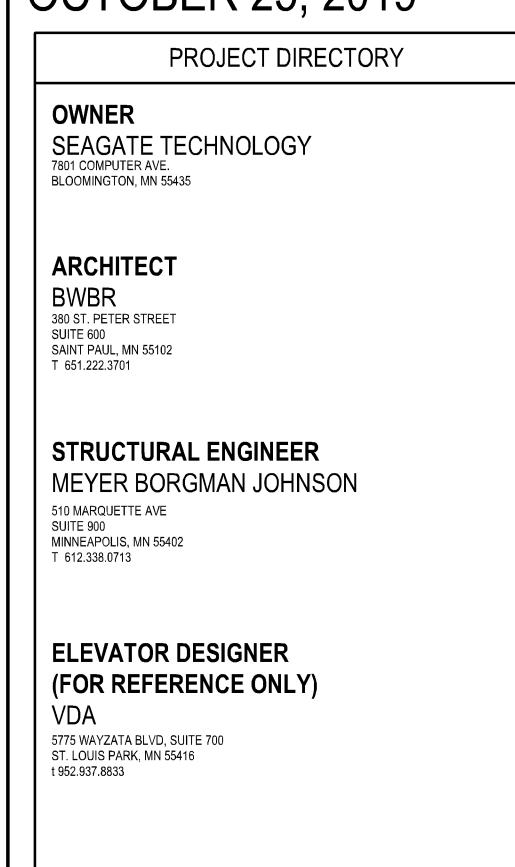

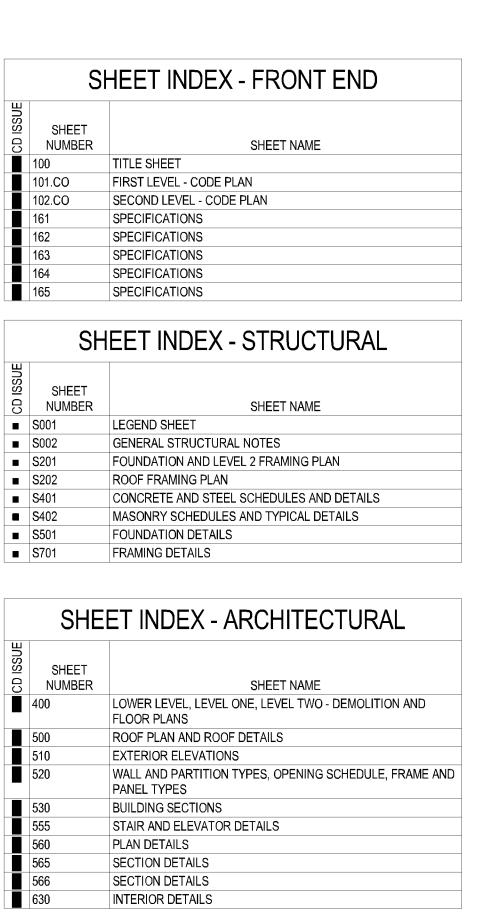

SHEET INDEX - ELEVATOR


HATCH AND MACHINE ROOM PLAN


NUMBER

DETAILS


SECTION

SHEET NAME

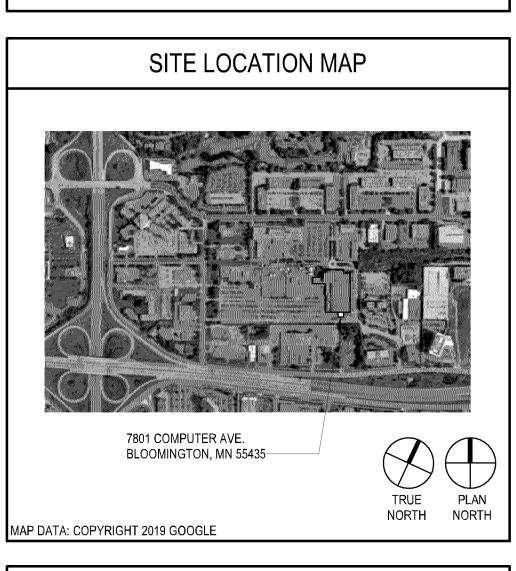

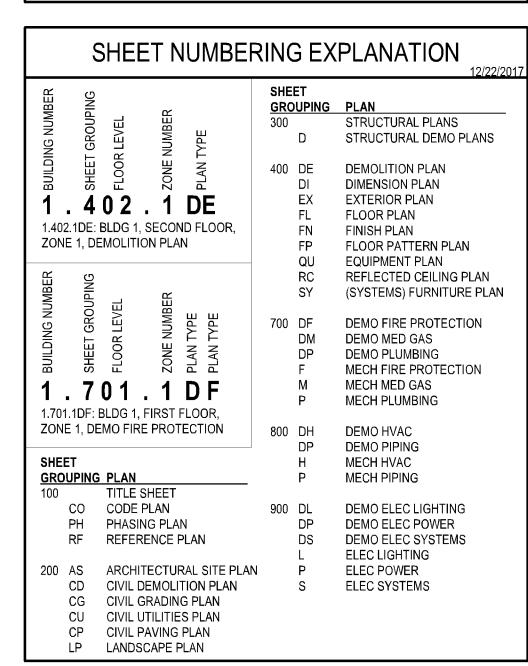


		NOT ISSUED
I		ISSUED
	R	ISSUED FOR REFERENCE ONL
	N	ISSUED AS NOTED

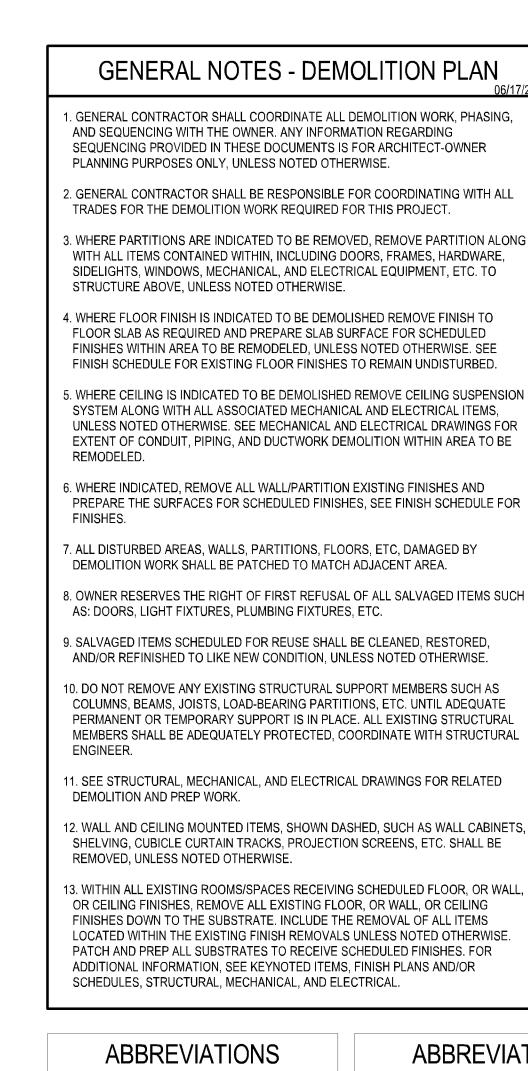

DE01		KEYNOTE	KEYNOTE A N			
		PARTITION OR WALL TO BE DEMOLISHED				
		PARTITION OR WALL TO REMAIN				
		DOOR, FRAME, AND HARDWARE TO BE DEMOLISHED	HARDWARE TO BE			
		DOOR, FRAME, AND HARDWARE TO REMAIN				
			DASHED LINES INDICATE AN ITEM TO BE REMOVED, UNLESS NOTED OTHERWISE			
	·	CONSTRUCTION LIMITS	_			
		NOTE: NO	NOTE: NOT ALL SYMBOLS MAY BE USED ON EACH PLA			
	K	EYNOTES - DE	MOLITION	PLAN		
REV	(XX##)	EYNOTES - DE				
REV			NOTES MAY BE USED			
REV	⟨xx##	NOTE: NOT ALL KEYN DEMOLISH EXISTING LOUVI CUT OPENING IN EXISTING	NOTES MAY BE USED ER EXTERIOR WALL FOR	ON EACH DRAWING		
REV	XX## DE01	NOTE: NOT ALL KEYN	NOTES MAY BE USED ER EXTERIOR WALL FOR T OF OPENING WITH PARATE CONTRACT.	ON EACH DRAWING R NEW MECHANICAL DRAWIN		
REV	XX## DE01	NOTE: NOT ALL KEYN DEMOLISH EXISTING LOUVI CUT OPENING IN EXISTING DOOR,COORDINATE HEIGH PROVIDED AS PART OF SER	NOTES MAY BE USED ER EXTERIOR WALL FOR T OF OPENING WITH PARATE CONTRACT. DRMATION. DW, PREPARE OPENI	ON EACH DRAWING  R NEW MECHANICAL DRAWIN SEE STRUCTURAL  NG FOR NEW DOOR. S		
REV	DE01 DE02	NOTE: NOT ALL KEYN DEMOLISH EXISTING LOUVI CUT OPENING IN EXISTING DOOR,COORDINATE HEIGH PROVIDED AS PART OF SEE DRAWINGS FOR MORE INFO DEMOLISH EXISTING WINDS	NOTES MAY BE USED ER EXTERIOR WALL FOR T OF OPENING WITH PARATE CONTRACT. DRMATION. DW, PREPARE OPENI URAL DRAWINGS FOR SH OPENING IN EXIST	ON EACH DRAWING  R NEW MECHANICAL DRAWIN SEE STRUCTURAL  NG FOR NEW DOOR. S R MORE INFORMATION TING EXTERIOR WALL. PENING ON LEVEL 1, V		
REV	DE01 DE02 DE03	NOTE: NOT ALL KEYN DEMOLISH EXISTING LOUVI CUT OPENING IN EXISTING DOOR,COORDINATE HEIGH PROVIDED AS PART OF SEF DRAWINGS FOR MORE INFO DEMOLISH EXISTING WINDO FLOOR PLAN. SEE STRUCT CUT 11'-0" WIDE X 12'-0" HIG OPENING TO MATCH ELEVA	NOTES MAY BE USED ER EXTERIOR WALL FOR T OF OPENING WITH PARATE CONTRACT. DRMATION. DW, PREPARE OPENI URAL DRAWINGS FOR SH OPENING IN EXIST ATOR DOOR CLEAR OF	ON EACH DRAWING  R NEW MECHANICAL DRAWIN SEE STRUCTURAL  NG FOR NEW DOOR. S R MORE INFORMATION ING EXTERIOR WALL. PENING ON LEVEL 1, V		
REV	DE01 DE02 DE03 DE04	NOTE: NOT ALL KEYN DEMOLISH EXISTING LOUVI CUT OPENING IN EXISTING DOOR,COORDINATE HEIGH PROVIDED AS PART OF SEF DRAWINGS FOR MORE INFO DEMOLISH EXISTING WINDO FLOOR PLAN. SEE STRUCT CUT 11'-0" WIDE X 12'-0" HIGO OPENING TO MATCH ELEVA SEE STRUCTURAL DRAWIN	NOTES MAY BE USED ER EXTERIOR WALL FOR T OF OPENING WITH PARATE CONTRACT. DRMATION. DW, PREPARE OPENI URAL DRAWINGS FOR SH OPENING IN EXIST ATOR DOOR CLEAR OF GS FOR MORE INFOR ES EXTENTS OF ACT	ON EACH DRAWING  R NEW MECHANICAL DRAWIN SEE STRUCTURAL  NG FOR NEW DOOR. S R MORE INFORMATION TING EXTERIOR WALL. PENING ON LEVEL 1, V RMATION. TO BE DEMOLISHED		

ABBREVIATIONS		ABBREVIATIONS			ABBREVIATIONS		
	TERM	F0	TERM	OT	TERM		
C CC	AIR CONDITIONING ACCESSIBLE	FG FRP	MONOLITHIC GLASS, FLAT GLAZING FIBERGLASS REINFORCED PLASTIC	QT QTB	QUARRY TILE QUARRY TILE BASE		
CT	ACCUSTIC CEILING TILE	FRT	FIRE RETARDANT TREATED	QTY	QUANTITY		
)	ADDENDUM		FOOT, FEET	R	RADIUS		
ار ت	ADJUSTABLE	GA	GAUGE	RB	RESILIENT BASE		
FF	ABOVE FINISH FLOOR	GALV	GALVANIZED	RCP	REFLECTED CEILING PLAN		
rr HU	AIR HANDLING UNIT	GCMU	GLAZED CONCRETE MASONRY UNIT	RD RD	ROOF DRAIN		
			GLAZING FILM	REBAR	REINFORCING BAR		
L I T	ALUMINUM ALTERNATE		GROUND FAULT CIRCUIT INTERRUPTER	REF	REFERENCE		
LT			GLUED-LAMINATED	_	REFRIGERATOR		
MB P	AMBULATORY ACCESS PANEL		GLASS MASONRY UNIT	REFR			
		GMU GPBD		REINF REQD	REINFORCED, REINFORCING REQUIRED		
PPROX			GYPSUM BOARD HARDWARE	-			
RCH	ARCHITECTURAL			REV	REVISED, REVISION		
/UX	AUXILIARY		HOLLOW METAL	RF	RESILIENT FLOORING		
.V	AUDIO VISUAL	HORIZ	HORIZONTAL	RG	RADIATION SHIELDING GLASS		
WP	ACOUSTIC WALL PANEL	HPNT	HIGH-PERFORMANCE PAINT	RINS	RIGID INSULATION		
CMU	BURNISHED CONCRETE MASONRY UNIT	HR	HANDRAIL	RM	ROOM		
LDG	BUILDING		HOUR	RO	ROUGH OPENING		
LKG	BLOCKING		INSIDE DIAMETER	RP	RESINOUS PANEL		
3R	BRICK		INSULATED GLASS UNIT(S)	SC	SHOWER CURTAIN		
BRG	BEARING		INSULATION	SCHED	SCHEDULE		
BUR	BUILT-UP ROOFING		INTEGRAL BASE	SD	SOAP DISPENSER		
CC	CUBICLE CURTAIN		KEYBOARD TRAY	SDF	STATIC DISSIPATIVE FLOORING		
CCTV	CLOSED CIRCUIT TELEVISION	KD	KNOCKED-DOWN	SF	SQUARE FEET		
CF	CUBIC FOOT	LAV	LAVATORY	SIM	SIMILAR		
CFCI	CONTRACTOR FURNISHED CONTRACTOR INSTALLED	LB	POUNDS	SLR	SEALER		
CFM	CUBIC FEET PER MINUTE	LF	LINEAR FEET	SLW	SLOTTED WALL		
CG	CORNER GUARD	LG	LAMINATED GLAZING	SNT	SEALANT		
CJT	CONTROL JOINT	LVT	LUXURY VINYL TILE	SPD	SANITARY PRODUCT DISPENSER		
CLG	CEILING	MAX	MAXIMUM	SPEC	SPECIFICATION		
M	CULTURED MARBLE	MB	MARKER BOARD	SPR	SANITARY PRODUCT RECEPTACLE		
MU	CONCRETE MASONRY UNIT	MECH	MECHANICAL	SQ	SQUARE		
02	CARBON DIOXIDE	MFR	MANUFACTURER	SSM	SOLID SURFACE MATERIAL		
OMP	COMPUTER	MG	MIRRORED GLASS	SSNT	SECURITY SEALANT		
ONC	CONCRETE	MIN	MINIMUM	SST	STAINLESS STEEL		
CONT	CONTINUOUS	MIN	MINUTE	STC	SOUND TRANSMISSION COEFFICIENT		
CPT	CARPET		MIRROR	STD	STANDARD		
PTB	CARPET BASE		MISCELLANEOUS	STN	STONE		
R	CRASH RAIL		METAL LAMINATE	STRUC	STRUCTURAL		
T.	CERAMIC TILE		MASONRY OPENING	TB	TACKBOARD		
TB	CERAMIC TILE BASE	MTD	MOUNTED	TBD	TO BE DETERMINED		
Υ	CUBIC YARD		NOT APPLICABLE	TD	TISSUE DISPENSER		
EMO	DEMOLISH	NIC	NOT IN CONTRACT	TEL	TELEPHONE		
ET	DETENTION	No or #	NUMBER	TEMP	TEMPERATURE		
)F	DECORATIVE FILM		NOISE REDUCTION COEFFICIENT	TEMP	TEMPORARY		
)F )G	DECORATIVE FILM  DECORATIVE OR ART GLASS		ON CENTER	TER	TERRAZZO		
IIA	DIAMETER		OUTSIDE DIAMETER	TERB	TERRAZZO BASE		
IAG	DIAGONAL	OFCI	OWNER FURNISHED CONTRACTOR INSTALLED	TPH	TOILET PAPER HOLDER		
IM MC	DIMENSION	OFOI	OWNER FURNISHED OWNER INSTALLED	TS	TRANSITION STRIP		
WG	DRAWING	OPG	OPENING	TVD	TELEVISION		
WP	DECORATIVE WALL PANEL	OPP	OPPOSITE	TYP	TYPICAL		
A	EACH	ORD	OVERFLOW ROOF DRAIN	UC	UNDER CABINET / UNDER COUNTER		
IFS	EXTERIOR INSULATION FINISH SYSTEM	PCC	PRECAST CONCRETE	UNO	UNLESS NOTED OTHERWISE		
JT	EXPANSION JOINT		PENCIL DRAWER	UTIL	UTILITIES		
L	ELEVATION		PLASTIC GLAZING	UV	ULTRAVIOLET		
LEC	ELECTRIC, ELECTRICAL		PLASTIC LAMINATE	VAC	VACUUM		
LEV	ELEVATOR	PLF	POUNDS PER LINEAL FOOT	VAR	VARIES		
LF	ELASTOMERIC LIQUID FLOORING		PANEL, PANELING	VCT	VINYL COMPOSITION TILE		
М	ENTRANCE MAT	PNT	PAINT	VERT	VERTICAL		
Q	EQUAL	PR	PROPOSAL REQUEST	VG	VISION CONTROL GLAZING		
QPT	EQUIPMENT	PREP	PREPARATION	VIF	VERIFY IN FIELD		
XG	EXISTING	PROJ NO	PROJECT NUMBER	VOC	VOLATILE ORGANIC COMPOUND		
XT	EXTERIOR	PSF	POUNDS PER SQUARE FOOT	WC	WALL COVERING		
AB	FABRIC		POUNDS PER SQUARE INCH	WC	WATER CLOSET		
AF	FLUID-APPLIED FLOOR COATING		PAPER TOWEL DISPENSER	WD	WOOD		
AW	FLUID-APPLIED WALL COATING		PARTITION	WDB	WOOD BASE		
D	FLOOR DRAIN	PVC	POLYVINYL CHLORIDE	WG	WIRED GLASS		
E	FIRE EXTINGUISHER ON BRACKET		PROTECTIVE WALL COVERING	WP	WATERPROOFING		
EC		PWD		WT			
ĽU	FIRE EXTINGUISHER AND CABINET FINIISH FLOOR ELEVATION	QSM	PLYWOOD  QUARTZ SURFACE MATERIAL	WWF	WINDOW TREATMENT WELDED WIRE FABRIC		

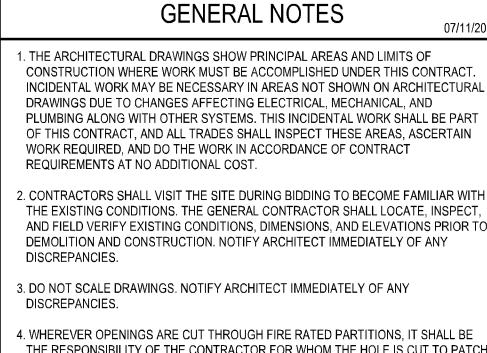

THE RESPONSIBILITY OF THE CONTRACTOR FOR WHOM THE HOLE IS CUT TO PATCH AND REPAIR ANY OPENING TO MAINTAIN THE INTEGRITY OF THE FIRE RATING.

GENERAL CONTRACTOR TO CHECK MECHANICAL DRAWINGS FOR EXISTING PIPES AND DUCTS FURRED IN WALLS. VERIFY SIZE AND LOCATION WITH MECHANICAL CONTRACTOR PRIOR TO PROCEEDING WITH REMODELING.

6. FIREPROOFING SHALL BE UNPIERCED. ANY SUBCONTRACTOR PENETRATING THE FIREPROOFING SHALL BE REQUIRED TO REPLACE FIREPROOFING TO THE ORIGINAL CONDITION AND FIRE RATING AT THE SUBCONTRACTOR'S EXPENSE.

7. EQUIPMENT UNIT DIMENSIONS ARE FOR PRODUCT DESCRIPTION ONLY, VERIFY SIZE WITH MANUFACTURER.

8. ALL DIMENSIONS PERTAINING TO MECHANICAL OR ELECTRICAL SERVICES OR EQUIPMENT SHALL BE VERIFIED WITH THE RESPECTIVE TRADE.9. ALL CONTRACTORS THAT PENETRATE AND/OR DISTURB ANY AREAS AT EXISTING

CONDITIONS SHALL PATCH AREA TO MATCH EXISTING ADJACENT AREA OR SURFACE AND PREPARE FOR SCHEDULED FINISH APPLICATION. COORDINATE WORK WITH GENERAL CONTRACTOR PRIOR TO PROCEEDING.

10. VERIFY HEIGHTS AND LOCATIONS OF ACCESS PANELS (AP) AND COORDINATE TYPES WITH TRADES WHICH REQUIRE THEM.

11. PROVIDE LINTELS AND FRAMING FOR GRILLES, LOUVERS, AND ROOF VENTS AS REQUIRED BY MECHANICAL CONTRACTOR, VERIFY SIZE AND LOCATION.
12. STRUCTURAL, MECHANICAL, AND ELECTRICAL ABBREVIATIONS AND SYMBOLS MAY DIFFER FROM ARCHITECTURAL. SEE RESPECTIVE SECTIONS AND/OR DRAWINGS


13. AT MECHANICAL AND ELECTRICAL EQUIPMENT ROOMS, PROVIDE 3/4" FRT PLYWOOD BACKING BEHIND ALL SURFACE MOUNTED FIXTURES AND EQUIPMENT UNLESS NOTED OTHERWISE.

14. HOUSEKEEPING PADS SHALL BE PROVIDED BY TRADES WHICH REQUIRE THEM.

SEE MECHANICAL AND ELECTRICAL DRAWINGS FOR SIZES AND LOCATIONS.

15. ELEVATOR DRAWINGS SHALL BE PROVIDED BY OWNER AND ARE ISSUED FOR REFERENCE ONLY. GENERAL CONTRACTOR TO COORDINATE WITH ELEVATOR INSTALLER FOR ALL ELEVATOR REQUIREMENTS.

16. MECHANICAL, ELECTRICAL, AND TELECOMMUNICATIONS DESIGN SERVICES AND DOCUMENTATION FOR THIS PROJECT SHALL BE PROVIDED BY THE OWNER. THESE ARCHITECTURAL PLANS MAY INDICATE TYPES AND LOCATIONS OF VARIOUS HEATING, VENTILATION, PLUMBING, LIGHTING, POWER, FIRE PROTECTION, TELECOMMUNICATION, SECURITY, ETC DEVICES AS DISCUSSED WITH THE OWNER. THE OWNER SHALL PROVIDE ENGINEERING SERVICES TO EVALUATE THE APPROPRIATENESS, CODE CONFORMANCE, AND SERVICEABILITY OF THESE ITEMS AS WELL AS THE DESIGN OF THE REQUIRED BUILDING SYSTEMS.

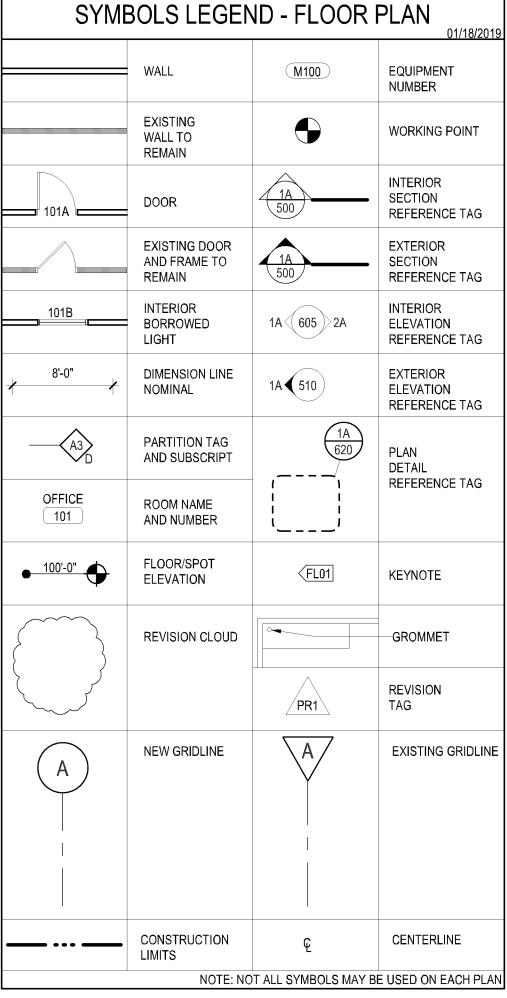

		CONSTRUCTION LIMITS	Ę.	CENTERLINE			
		NOTE: NO	T ALL SYMBOLS MAY BI	E USED ON EACH PLAN			
	KEYNOTES - FLOOR PLAN						
XX##	MOTE: NOT ALL KEYNOTES MAY BE USED ON EACH DRAWING						
_01	SURFACE MOUNTED FEC, TOP OF CABINET TO BE MOUNTED NO HIGHER THAN 48" AFF						
_02	FLOOR DRAIN WITH INDIRECT CONNECTION TO SANITARY, SEE MECHANICAL DRAWINGS PROVIDED BY OWNER. FINAL DRAIN LOCATION TO BE COORDINATED WITH ELEVATOR EQUIPMENT.						
_03	GRA	DE BEAM, SEE STRUCT	URAL DRAWINGS				
_04	PIT A	ACCESS LADDER					
_05	ELEVATOR, SEE ELEVATOR DESIGN DRAWINGS ISSUED AS PART OF SEPARATE CONTRACT.						
_06	HANDRAIL						
_07	NON PUBLIC STAIR GUARDRAIL WITH HANDRAIL						
_08	GUARDRAIL						
_09	9 REMOVABLE SECTION OF GUARDRAIL						
_10	CONCRETE CURB AT PERIMETER OF BUILDING, MATCH EXISTING						
_11	CON	CRETE CURB AT ELEVA	TOR SILL, SEE STRUCT	URAL DRAWINGS			
_12	12 TEMPORARY OPENING						
_13	SEE	SHEET 630 FOR CEILING	G DETAILS				
_14	DASHED LINE REPRESENTS PROFILE OF PLATFORM AND STAIR AT FIRST LEVEL						
_15	.15 CAST IN PLACE CONCRETE FOUNDATION WALL, SEE STRUCTURAL DRAWINGS						
_16	PAIN	IT HM DOOR AND FRAM	E TO MATCH BUILDING	STANDARD			
_17	PAR	TITION WIDTH TO MATC	H ADJACENT				
_18	PAIN	IT HM DOOR AND FRAM	E PNT2				
_19	CAS	T IN PLACE CONCRETE	LEDGE, SEE STRUCTUR	AL DRAWINGS			
_20	CLE	AN ROOM WALL PANEL					
_21		•	F DRAIN PIPING - COOR ROVIDED AS PART OF SI				
_22	SUM	P BASIN, SEE MECHANI	CAL DRAIWNGS PROVID	DED BY OWNER			
_23			OR CONTRACTOR IS RES F ELEVATOR RAILS TO S				

COORDINATE LOCATION OF SUPPORTS WITH GENERAL CONTRACTOR

SEAGATE BLOOMINGTON ELEVATOR ADDITION

3	В	W	В	R
			380 St. Peter S	Street, Ste. 600
			Saint Paul, MI	V 55102
			651.222.3701	

Consultants

This document may be an electronic file or may be printed from an electronic file provided to the user. It is the sole responsibility of the user to ensure that the content and quality is consistent with the content and quality of the original documents on file at BWBR.

I hereby certify that this plan, specification or report was prepared by me or under my direct supervision and that I am a duly Licensed/Registered Architect under the laws of the State of Minnesota

I hereby certify that this plan, specification or report was prepared by me or under my direct supervision and that I am a duly Licensed/Registered Architect under the laws of the State of Minne

Name

Douglas D. Wild


Date 10/25/2019

Lic./Reg. No. 23874

Issued For

CD ISSUE

10/25/2019

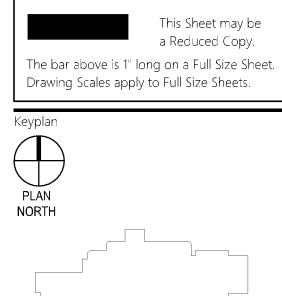

3.2019201.00 KN

Sheet Title

TITLE SHEET

00

## **CASE FILE #PL2020-19**

APPROVED
ZONING REVIEW ONLY
NMJ 03/10/2020

1H NORMANDALE CAMPUS ARCHITECTURAL SITE PLAN
1" = 60'-0"

77TH STREET WEST PROPOSED ADDITION PROPERTY LINE AS MEASURED PER DIMENSIONS ON HENNEPIN COUNTY STRIPE EXISTING PARKING STALLS TO INDICATE NO PARKING. MATCH CAMPUS STANDARD PAINT TYPE AND PATTERN FOR NO PARKING PER CITY OF BLOOMINGTON ZONING CODE DISTRICT I-2 MINIMUM PUBLIC STREET RIGHT OF WAY FOR FUTURE 78TH ST CIRCLE WEST

SEAGATE
BLOOMINGTON
ELEVATOR
ADDITION

BWBR

380 St. Peter Street, Ste. 60 Saint Paul, MN 55102

Consultants

This document may be an electronic file or may be printed from an electronic file provided to the user. It is the sole responsibility of the user to ensure that the content and quality is consistent with the content and quality of the

Name

Douglas D. Wild

Date 10/25/2019

Divine a price of the supervision and that I am a duly the State of Market under the laws of the State of

Issued For

D-02 D1/23

This Sheet may be a Reduced Copy. The bar above is 1" long on a Full Size Sheet. Drawing Scales apply to Full Size Sheets.

Comm. No. Drawn
3.2019201.00 NR

Sheet Title

ARCHITECTURAL SITE


PLAN

neet No.


400.AS


#### **APPROVED ZONING REVIEW ONLY** NMJ 03/10/2020

### **CASE FILE #PL2020-19**

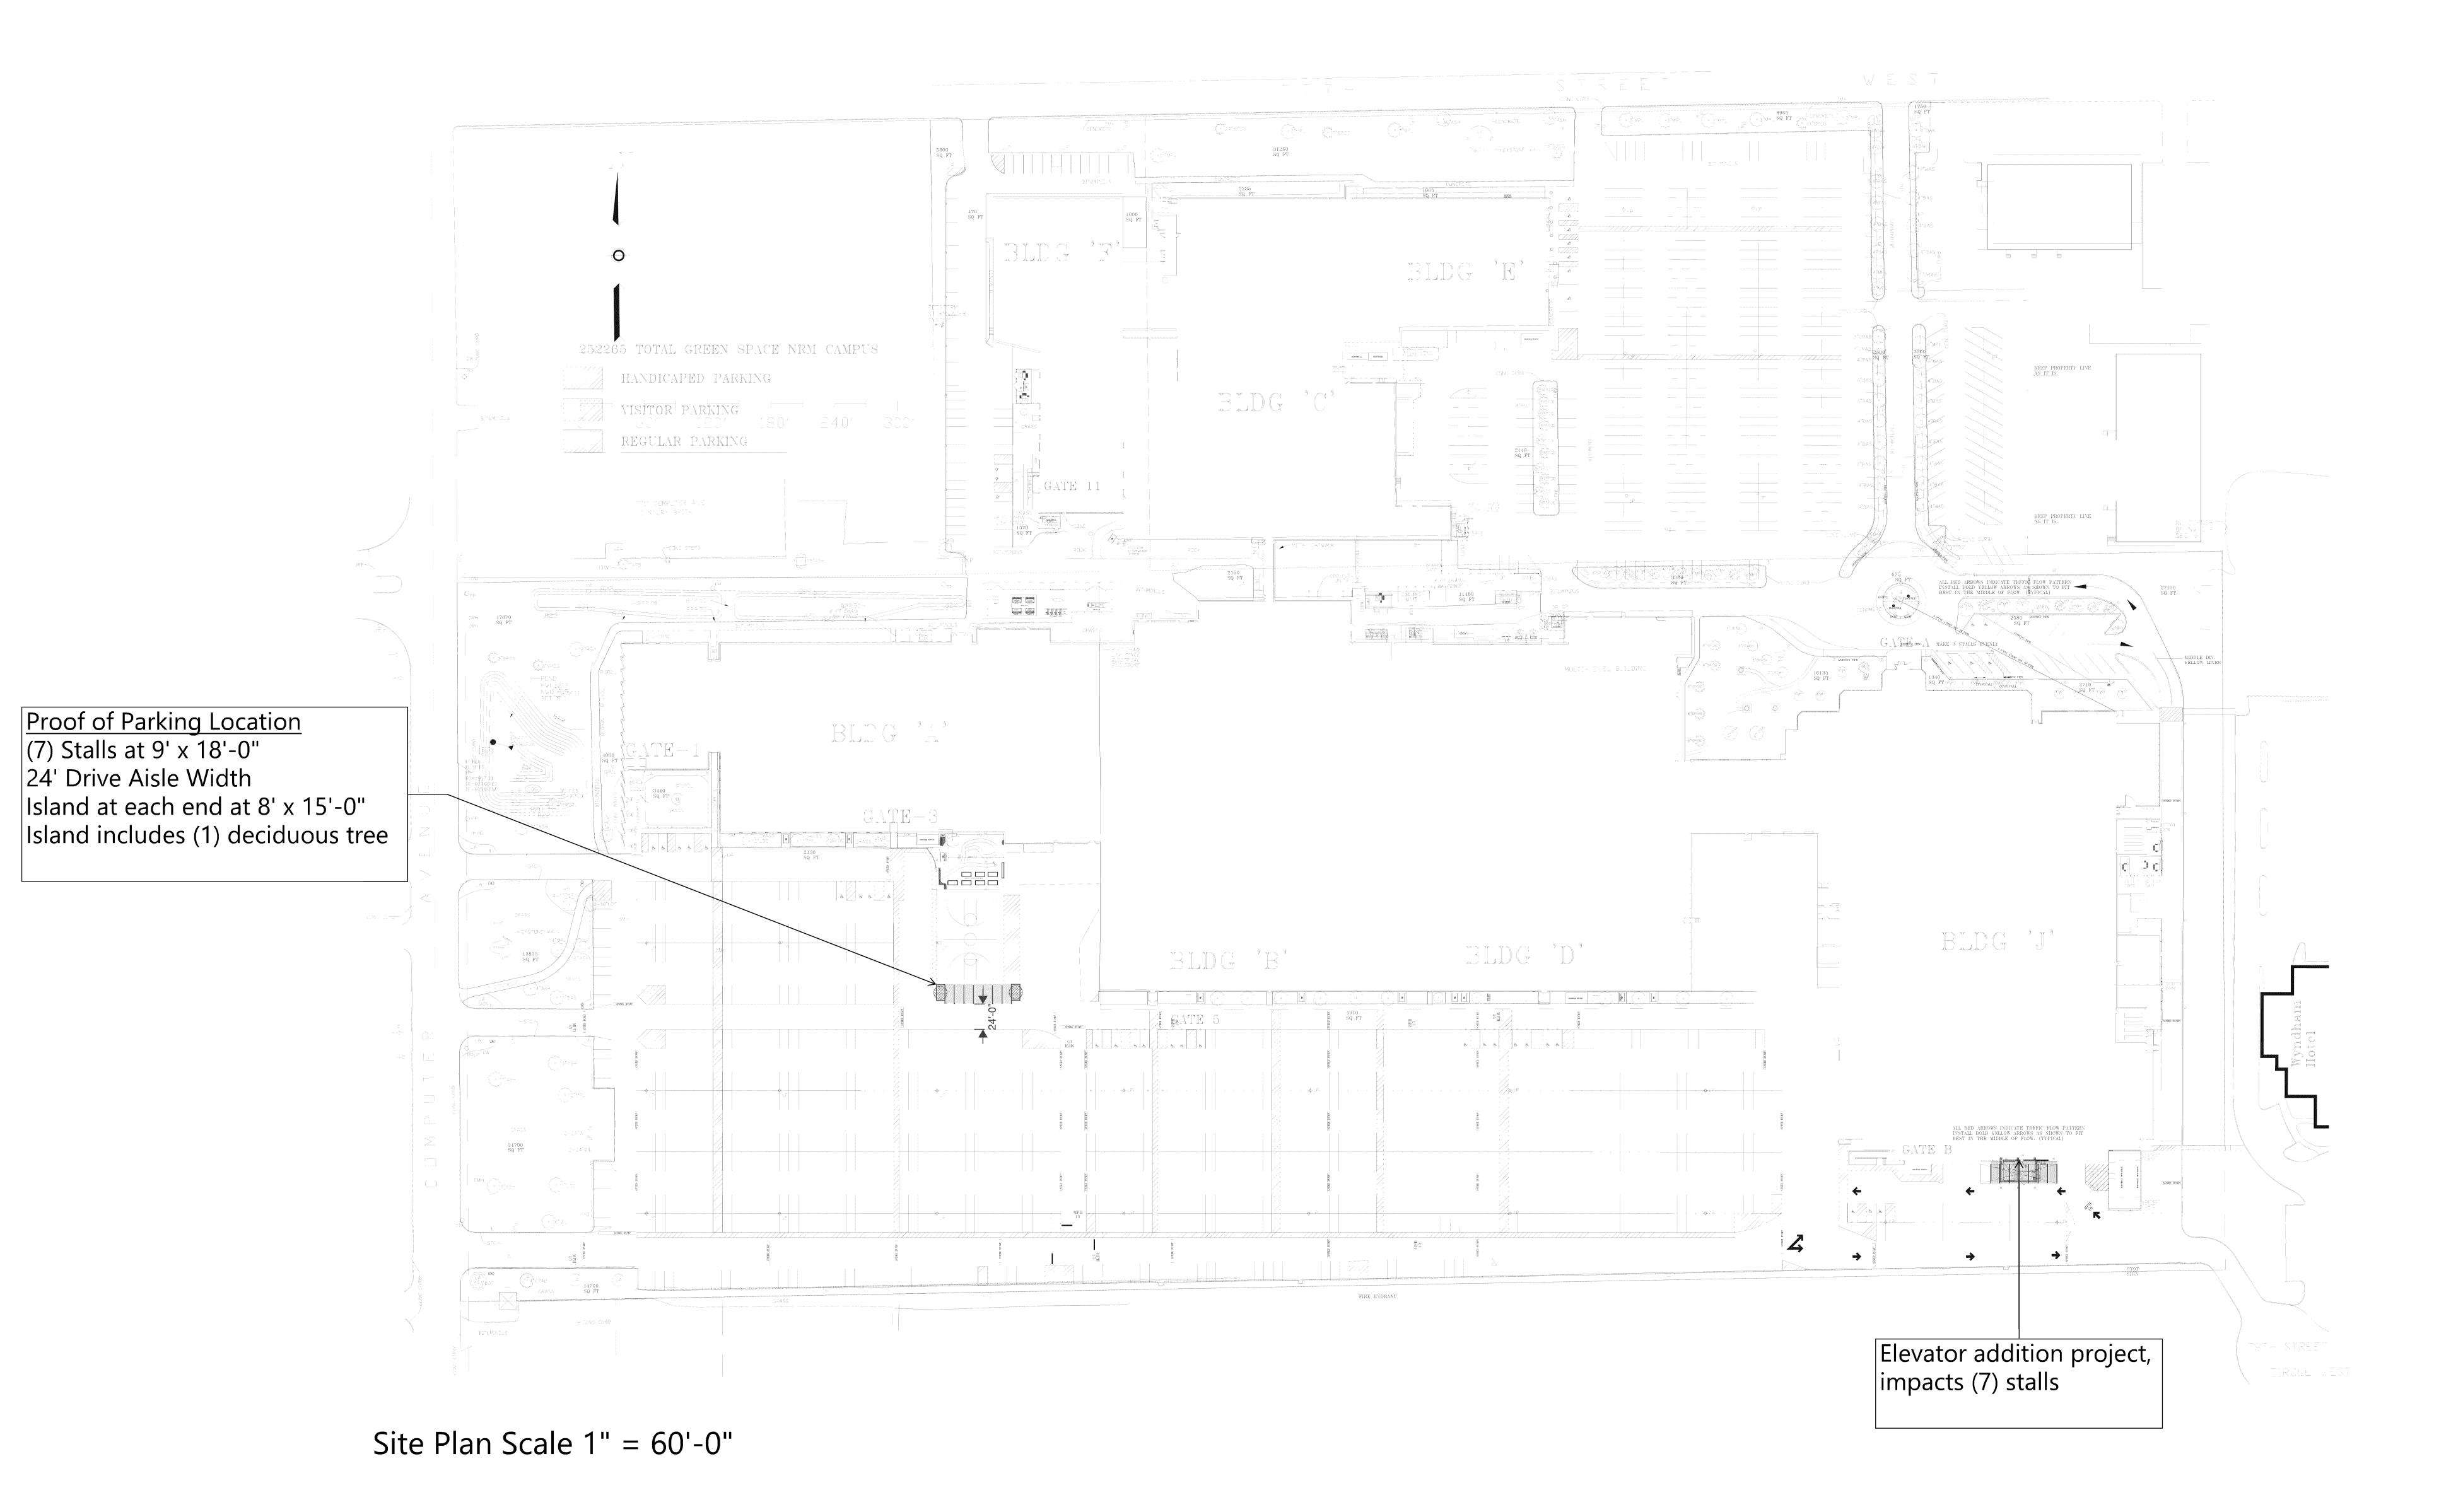



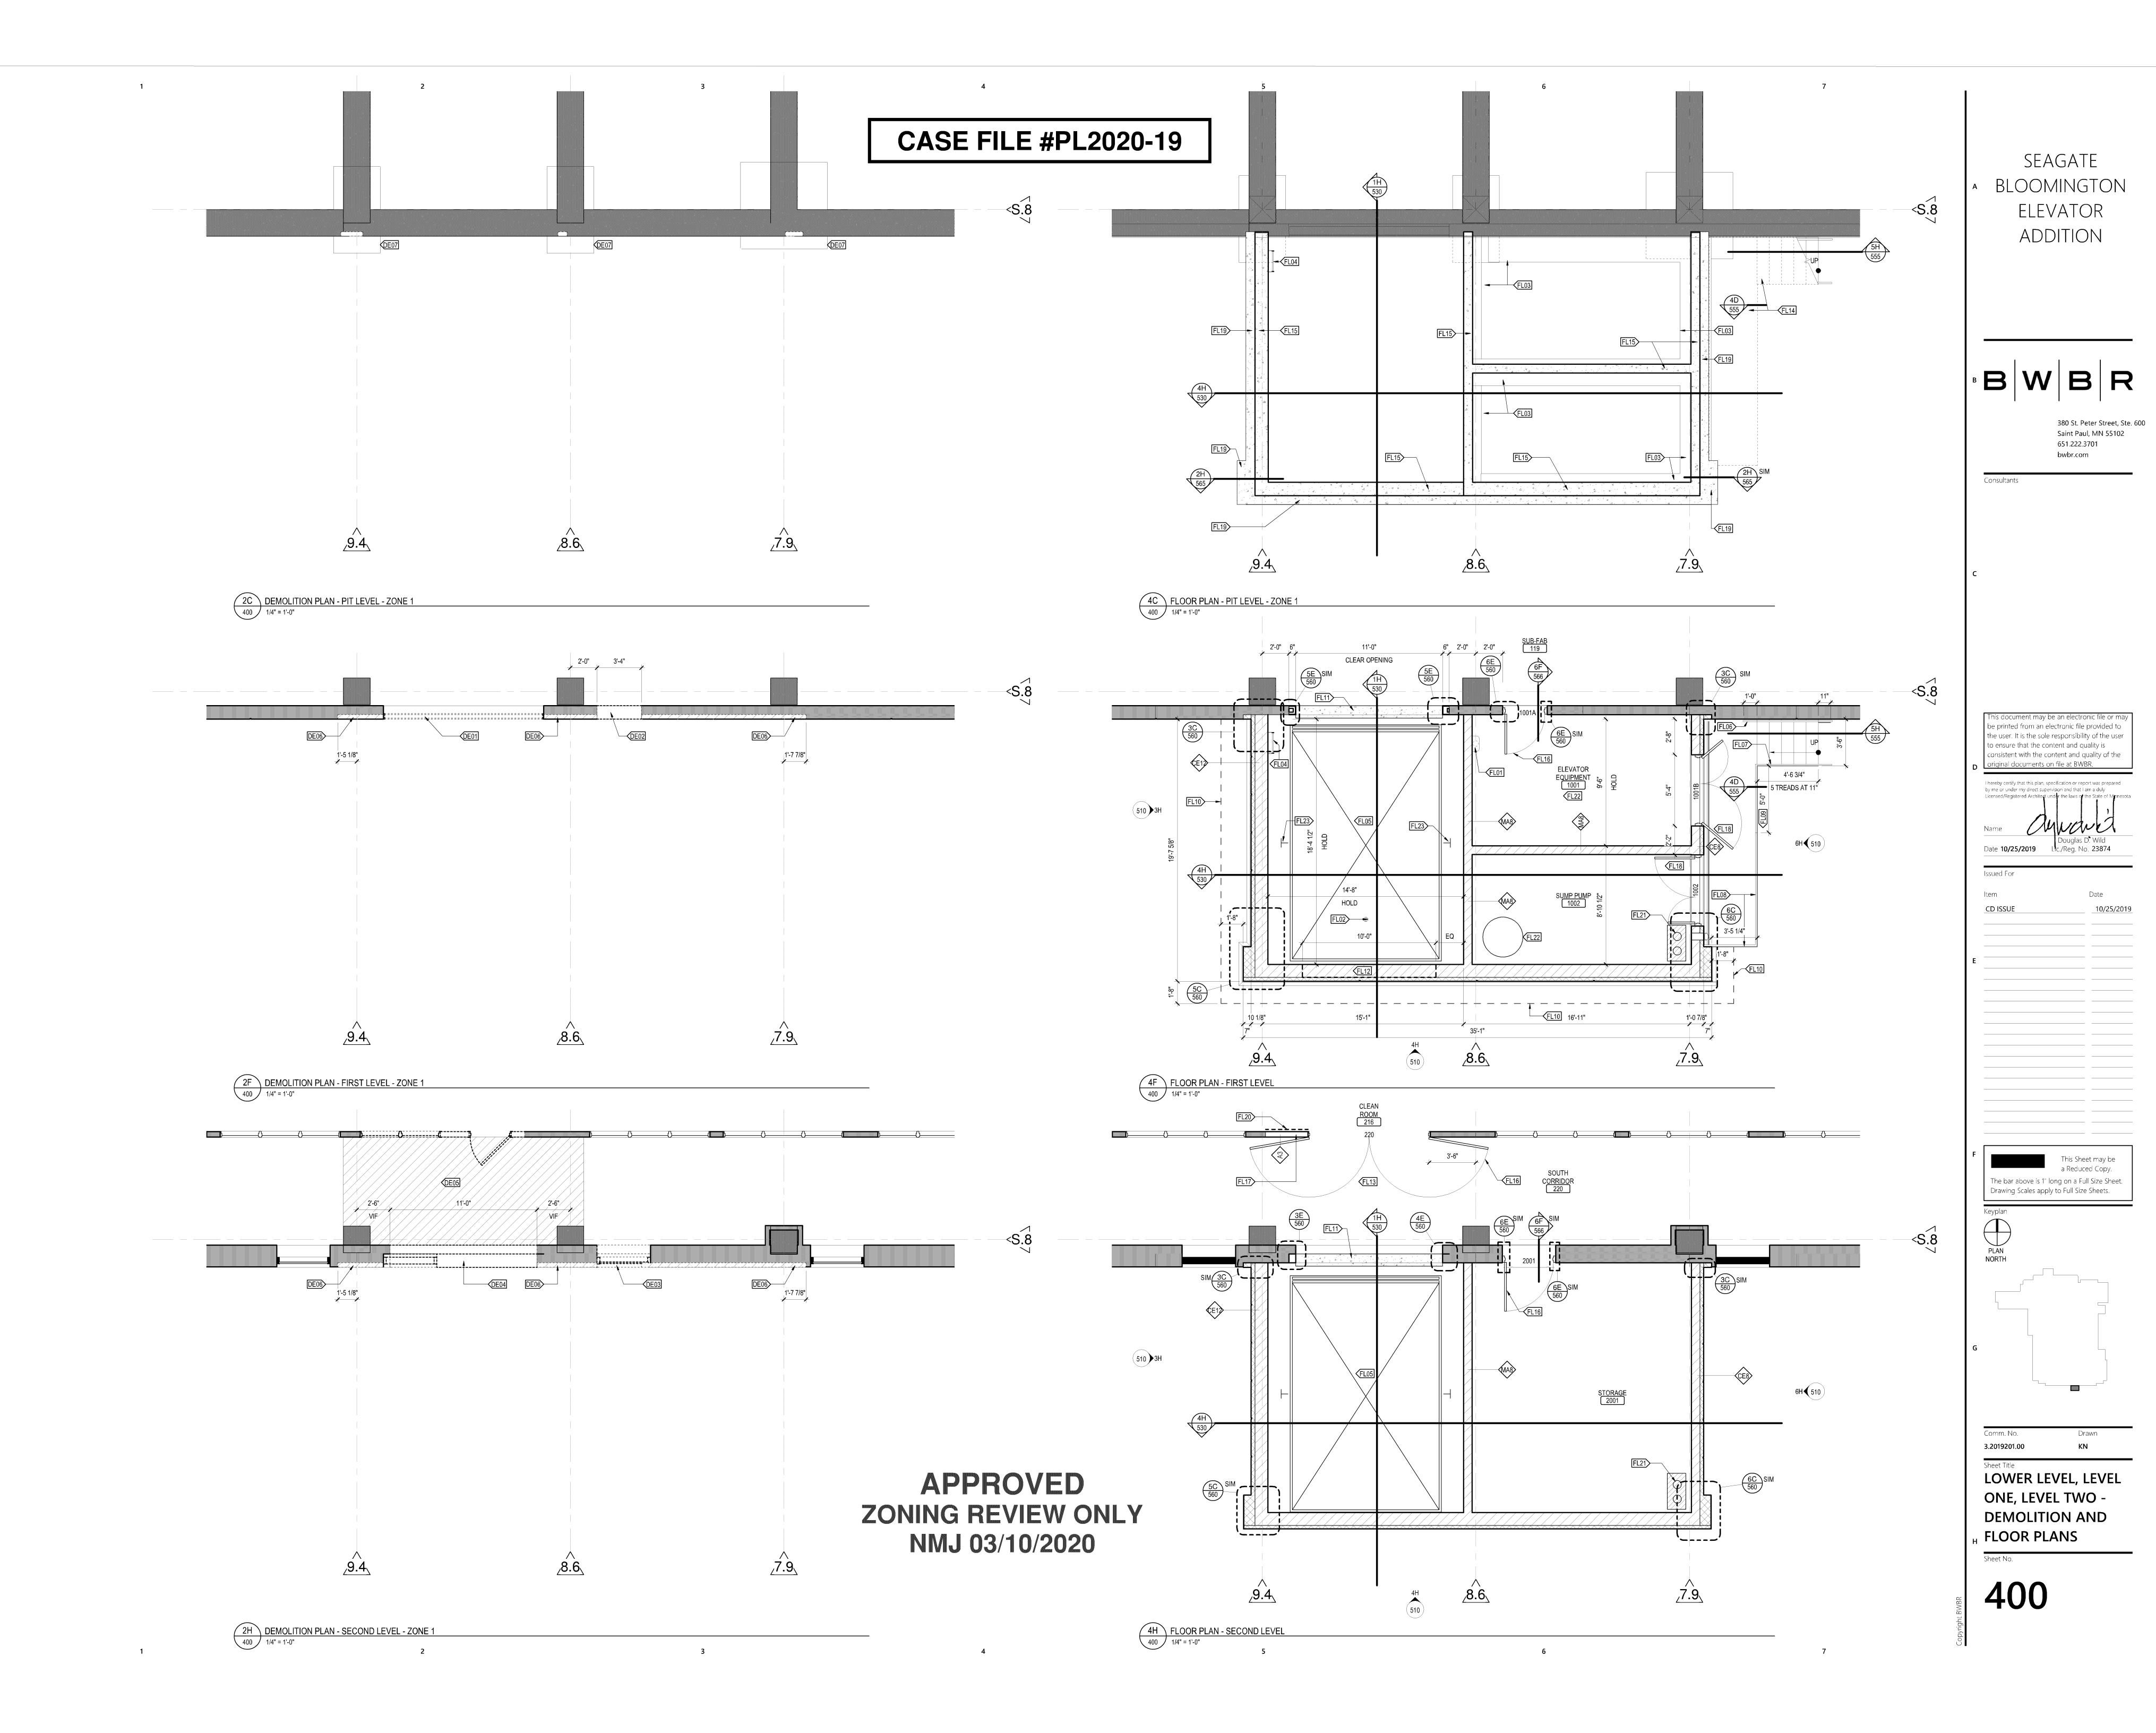

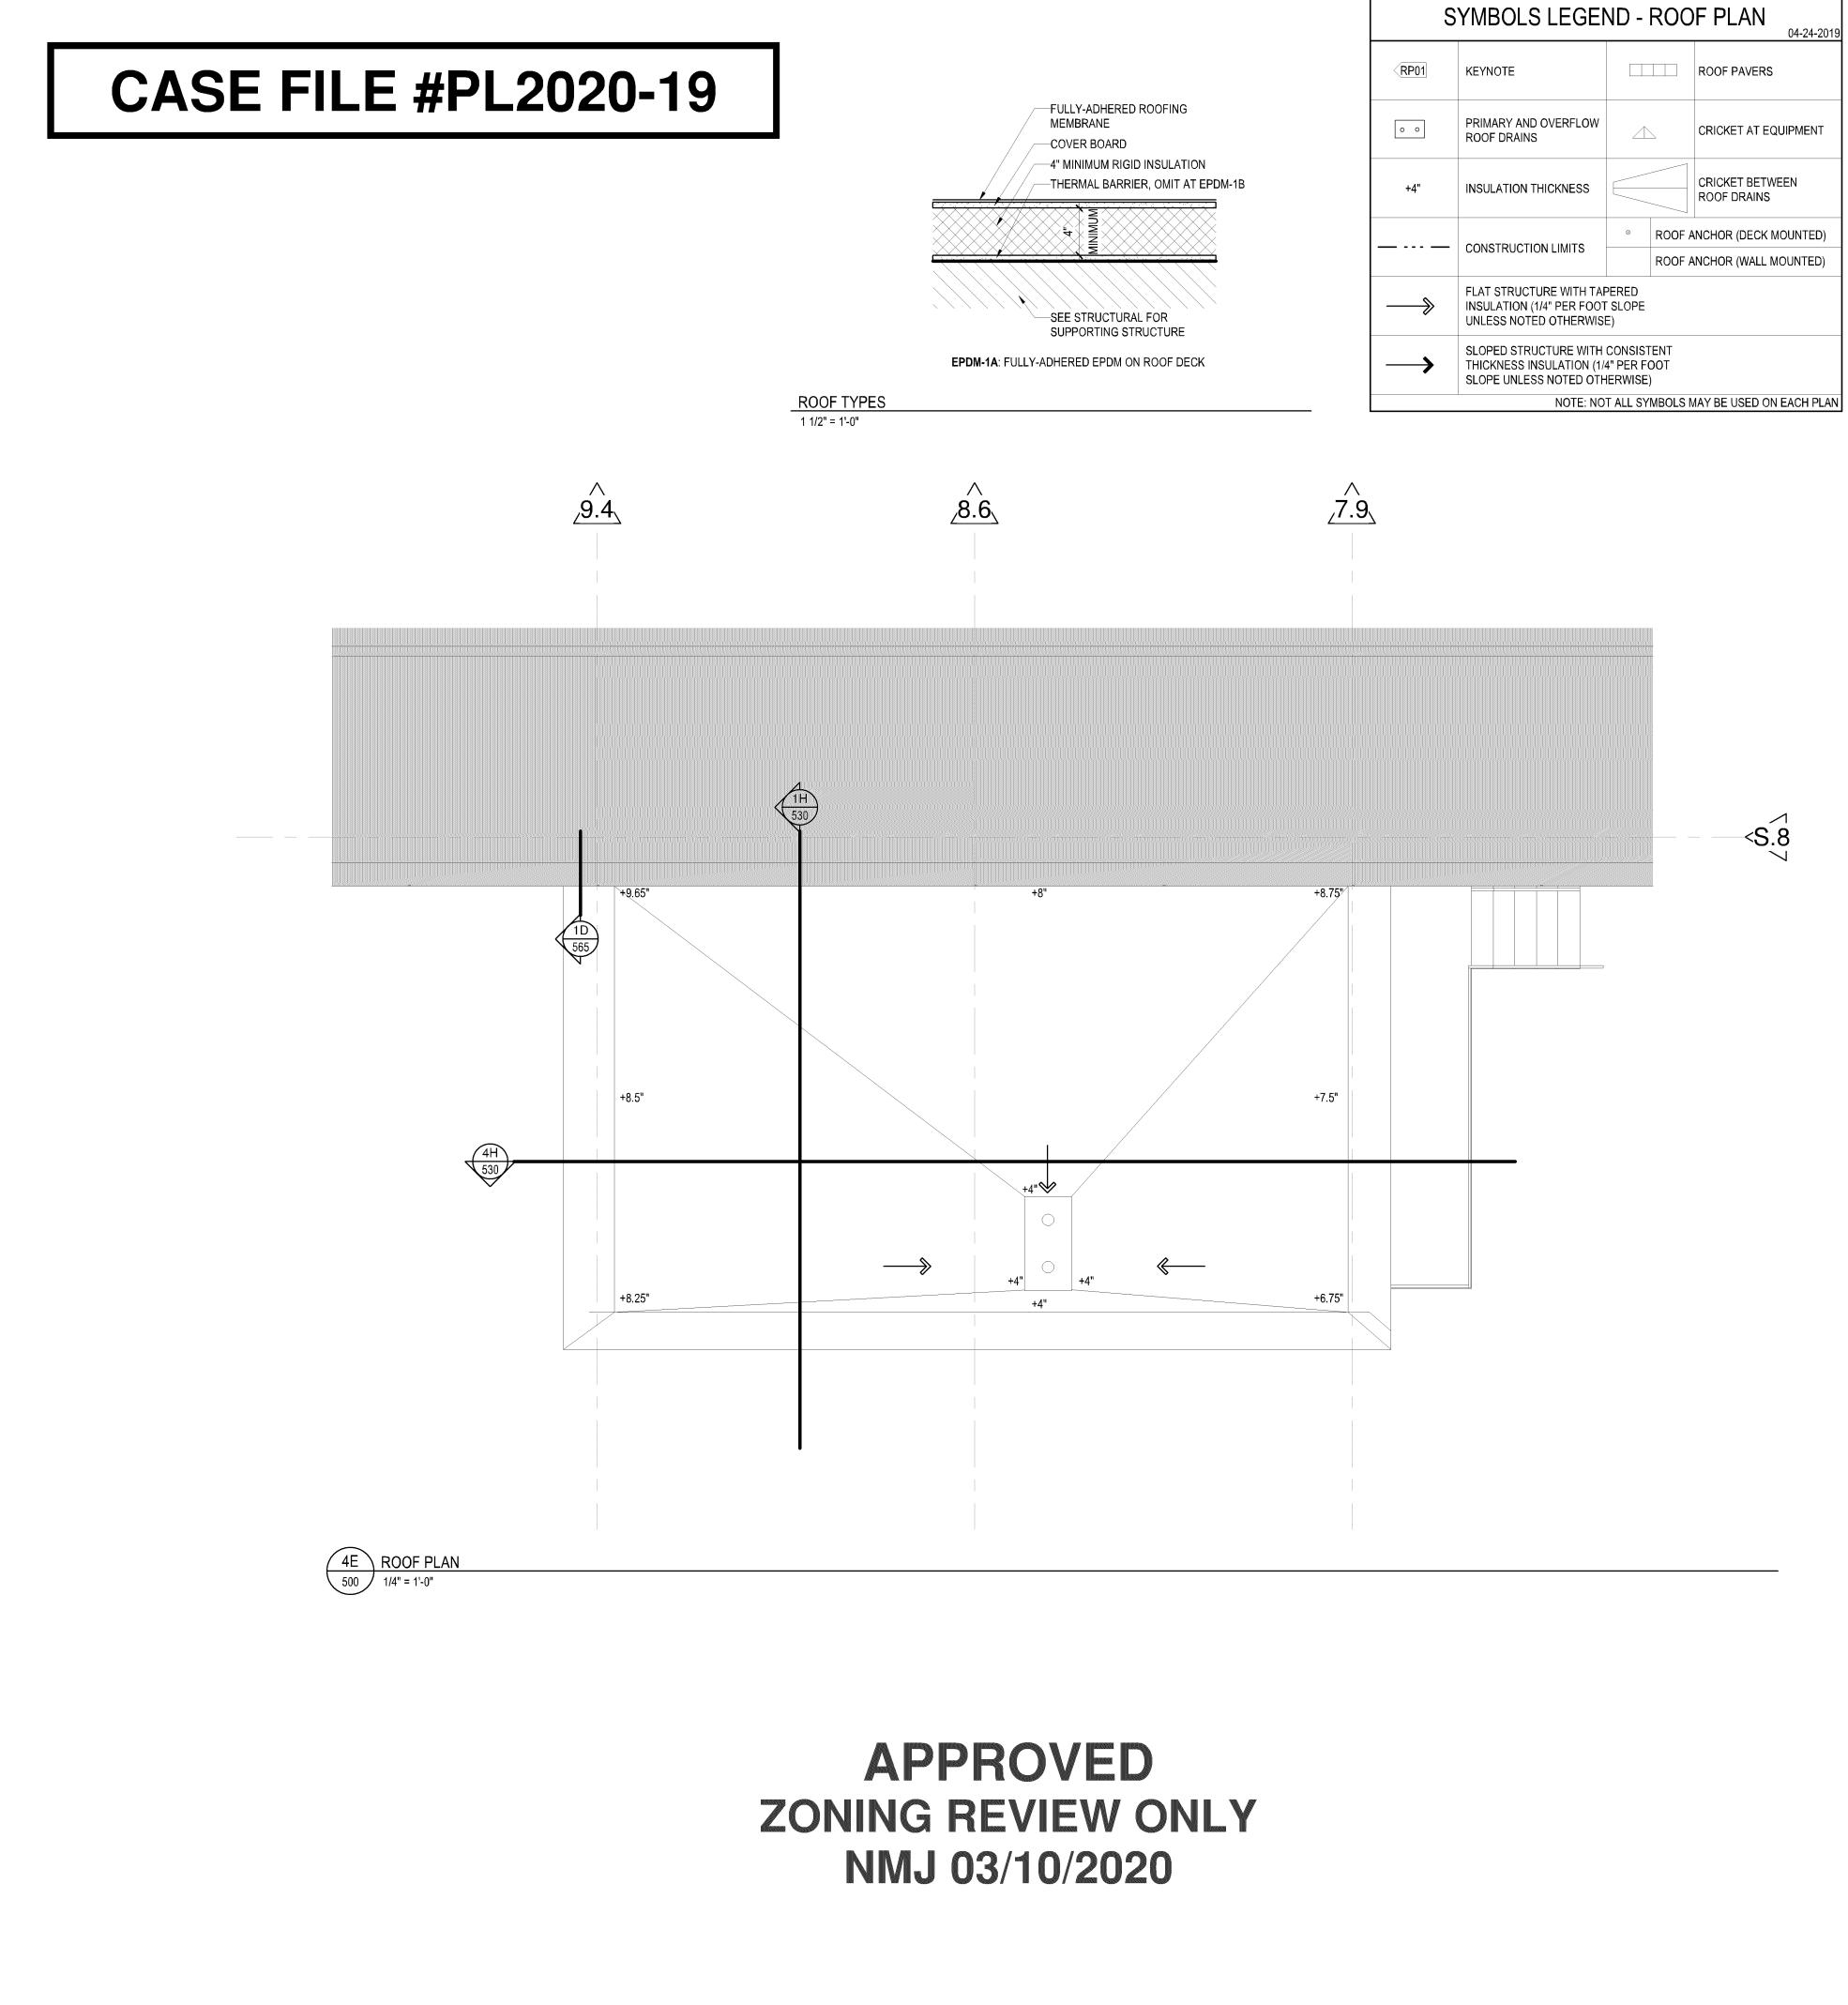

SEAGATE

A BLOOMINGTON

ELEVATOR

ADDITION

BWBR

380 St. Peter Street, Ste. 600 Saint Paul, MN 55102 651.222.3701 bwbr.com

Consultants

This document may be an electronic file or may be printed from an electronic file provided to the user. It is the sole responsibility of the user to ensure that the content and quality is consistent with the content and quality of the original documents on file at BWBR.

original documents on file at BWBR.

I hereby certify that this plan, specification or report was prepar by me or under my direct supervision and that I am a duly Licensed/Registered Architect under the laws of the State of Mi

te 10/25/2019 Li

tem Date

CD ISSUE 10/25/

This Sheet may be a Reduced Copy.

The bar above is 1" long on a Full Size Sheet.

Drawing Scales apply to Full Size Sheets.

PLAN NORTH

Comm. No. Drawn
3.2019201.00 KN

ROOF PLAN AND ROOF
DETAILS

t No.

500

