
# Knox & American II 1801 American Blvd W Bloomington MN 55431


# KNOX AND AMERICAN II




# PROJECT LOCATION AMERICAN BLVD-W PROJECT LOCATION Vicinity Site Location

# Address: 1801 American Blvd W Bloomington MN 55431

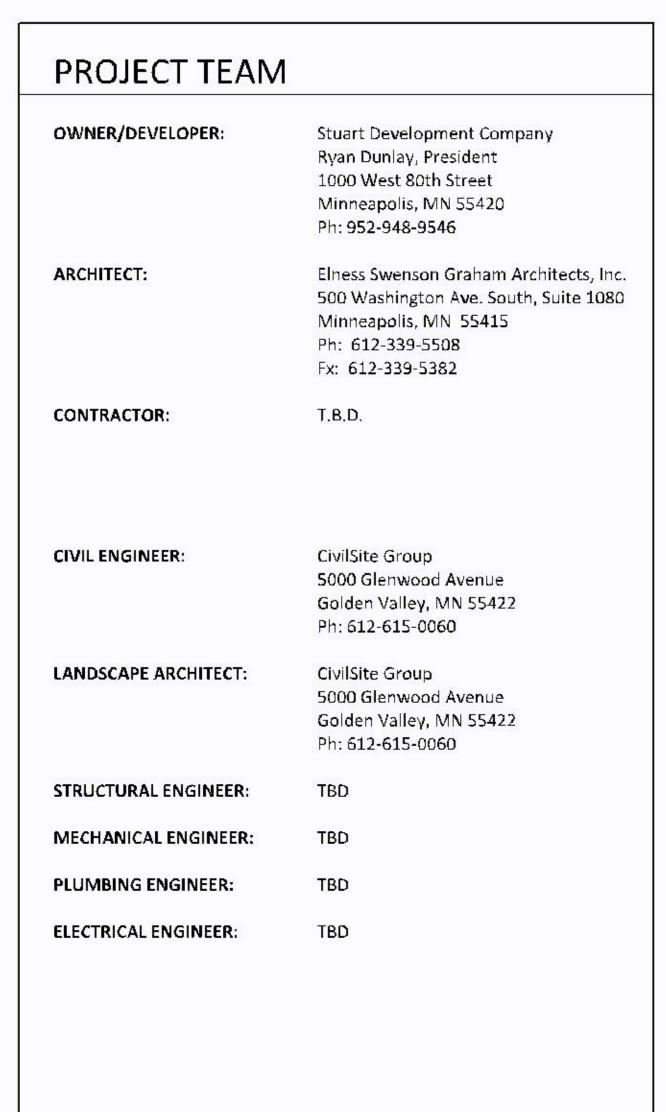

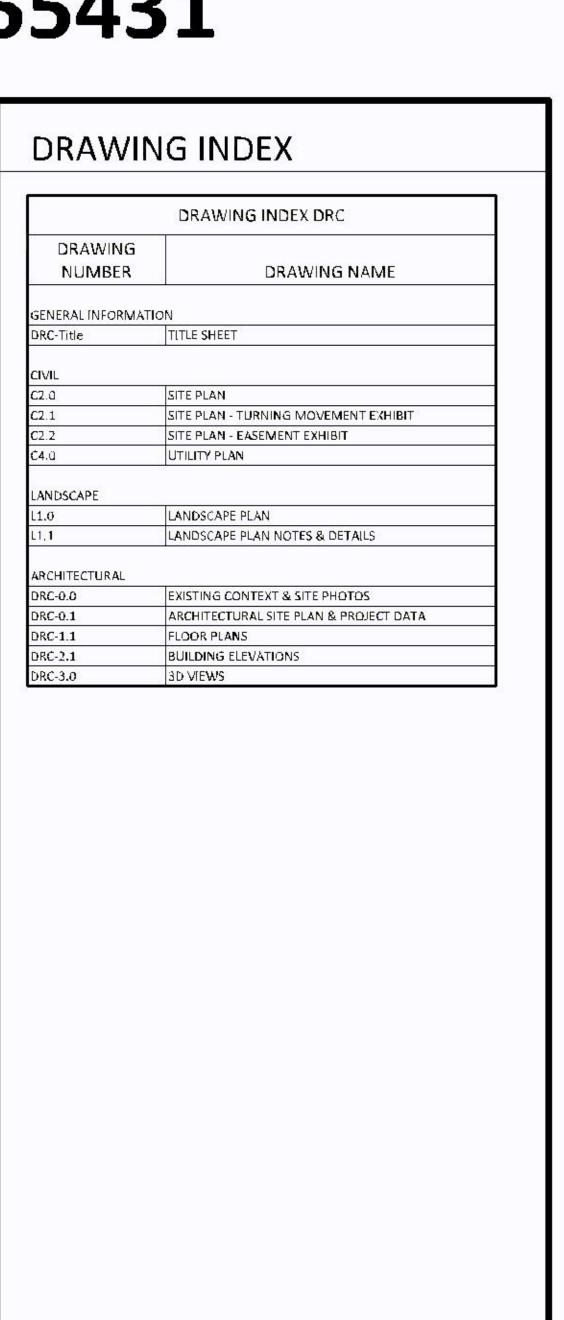

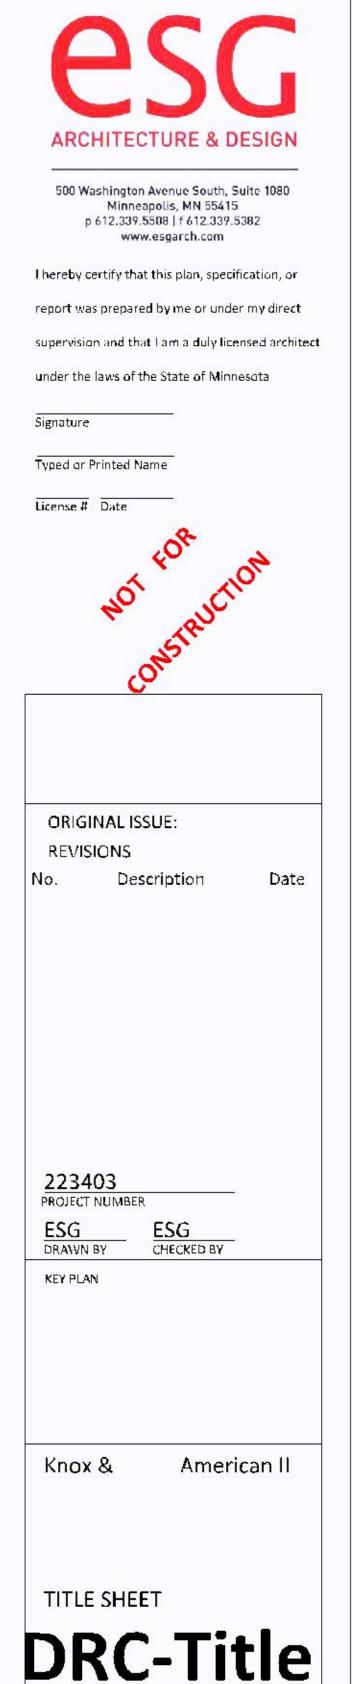

# Knox & American II

1801 American Blvd W Bloomington MN 55431




SITE PHOTO: VIEW SOUTHWEST TOWARD SITE




SITE PHOTO: VIEW SOUTHWEST AT NORTHERN EDGE



SITE PHOTO: VIEW SOUTH AT NORTHERN EDGE

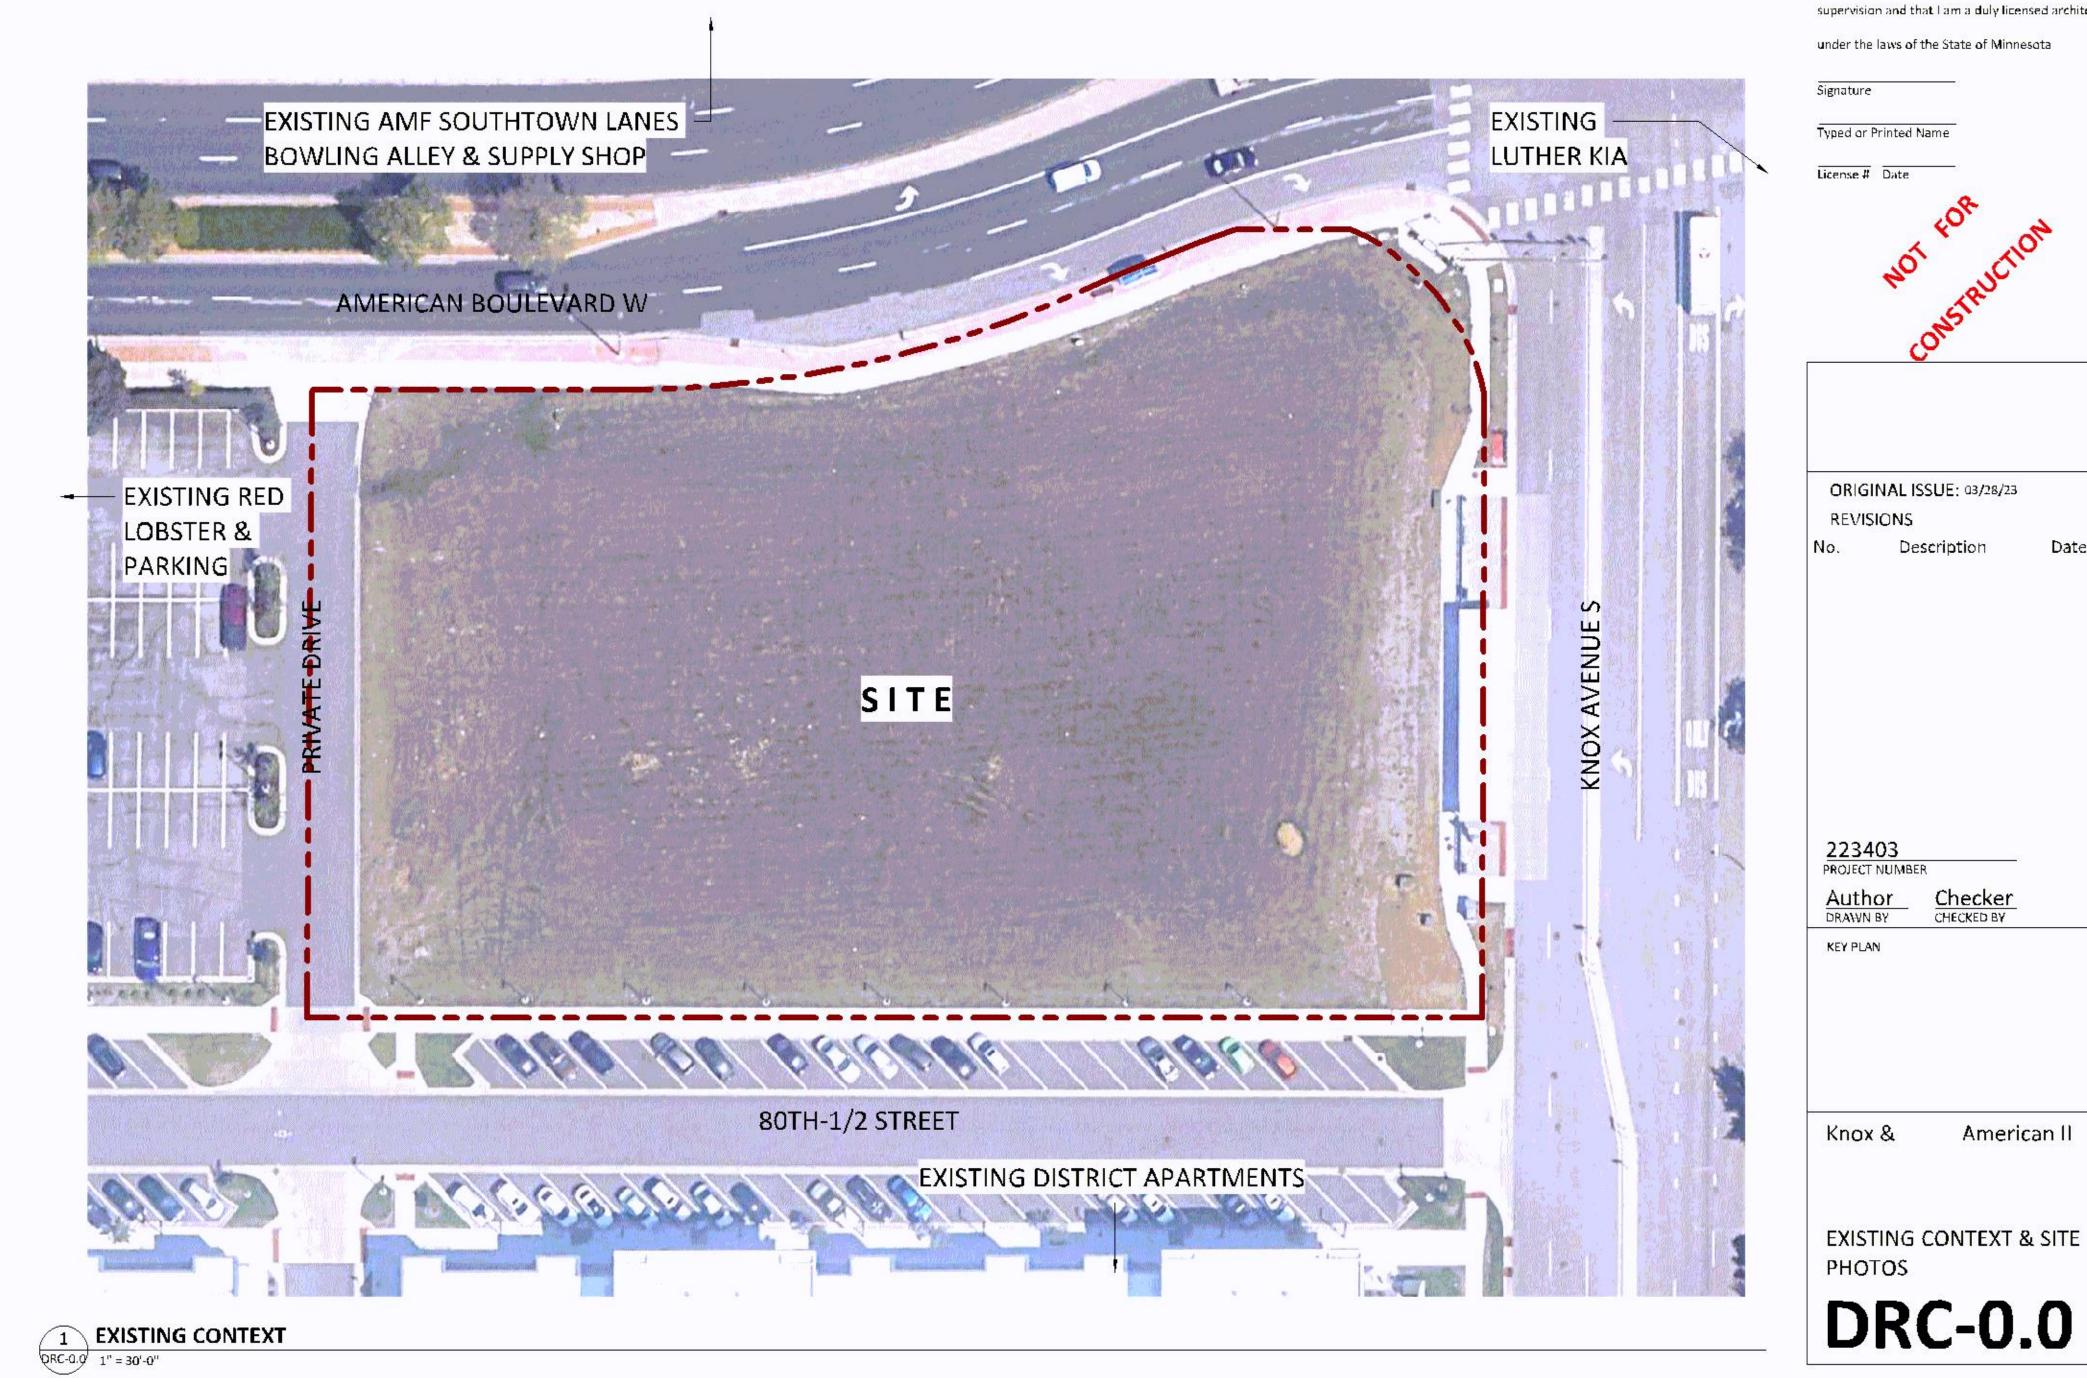

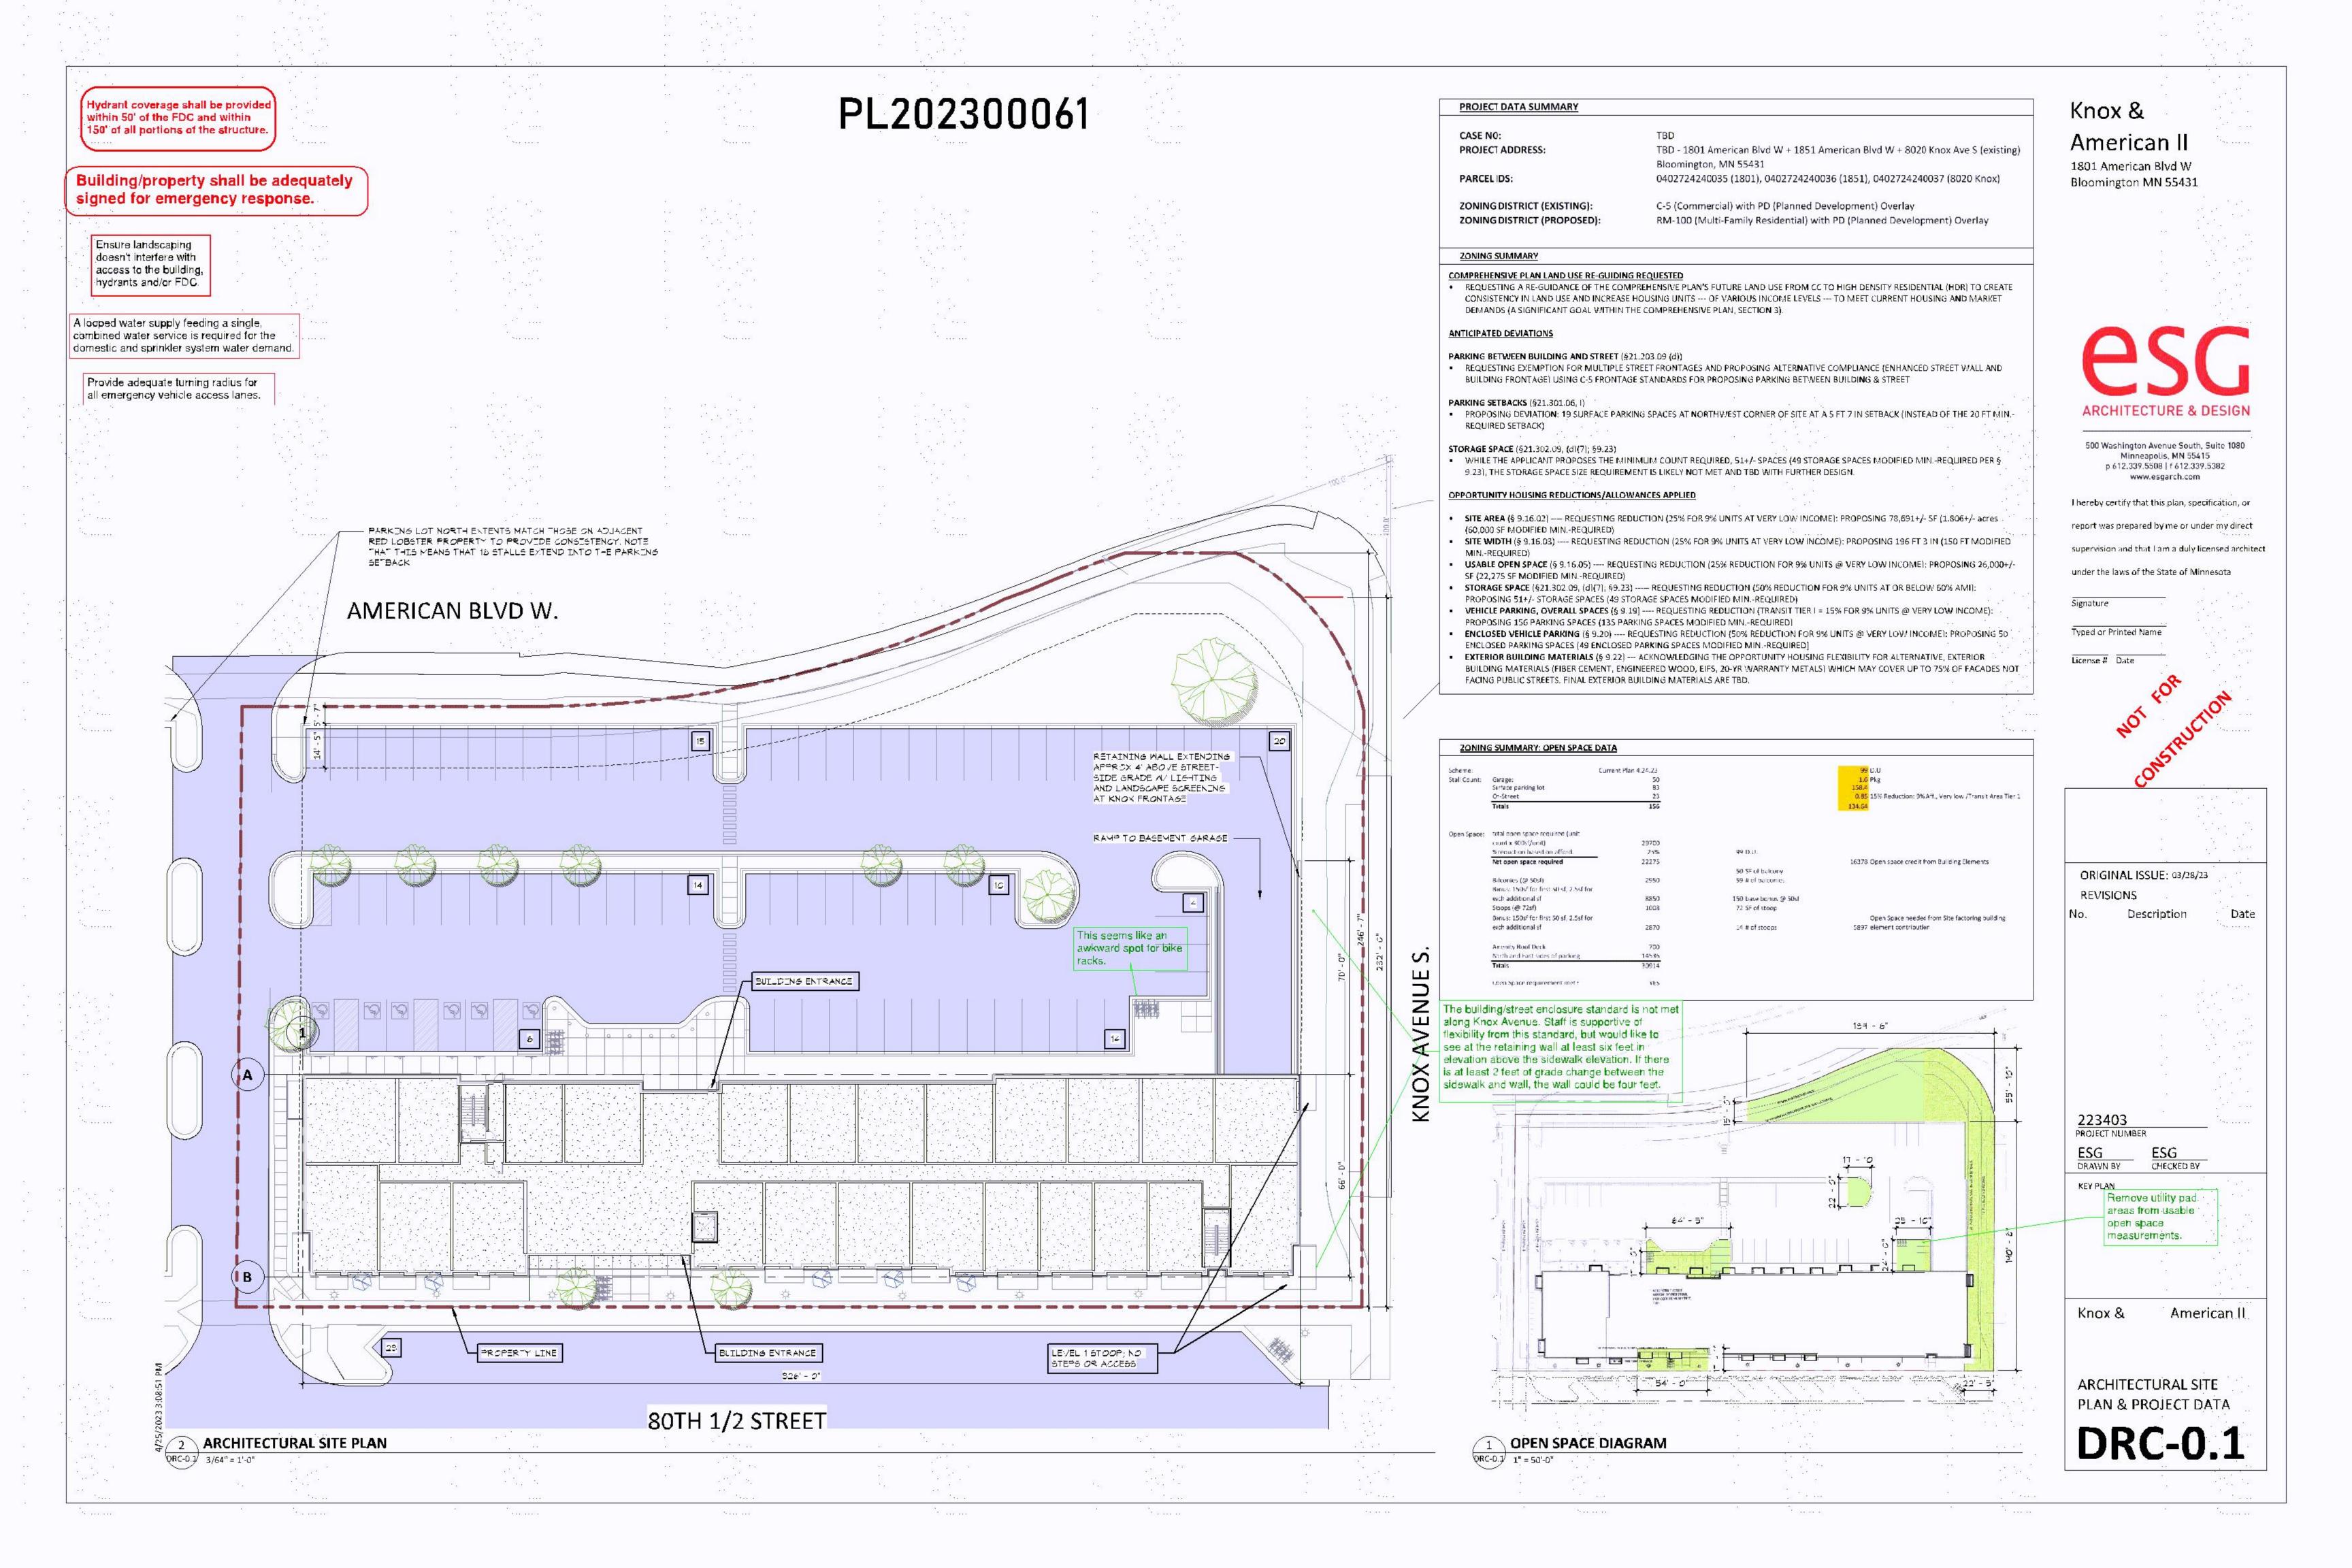

Emergency responder radio coverage meeting the requirements of appendix P in the 2020 MSFC shall be provided throughout the property and within the structures.

All exterior doors that allow access to the interior of the building(s) shall be numbered in a sequential order starting with the main entrance (public entrance) as number 1 and continue in a clockwise manner.

Standpipes requirement in all stairwells and hose valves shall be located at the floor landing

Access shall be provided to/from all stairwells on all floors and parking levels.

Fire alarm and annunciator panels and Knox box locations to be determined by the Fire Prevention Division. This project may require multiple panels and Knox boxes.

Standpipe coverage/hose valves shall be located in stairwells and within 200' of all areas.



Knox &

American II

1801 American Blvd W Bloomington MN 55431

> ESG ARCHITECTURE & DESIGN

500 Washington Avenue South, Suite 1080 Minneapolis, MN 55415 p 612.339.5508 | f 612.339.5382 www.esgarch.com

Thereby certify that this plan, specification, or

report was prepared by me or under my direct

supervision and that I am a duly licensed architect

under the laws of the State of Minnesota

Signature

Typed or Printed Name

License # Date



ORIGINAL ISSUE: 03/28/23
REVISIONS

Date

No. Description

223403

Author Checker
DRAWN BY CHECKED BY

KEY PLAN

Knox & American II

FLOOR PLANS

**DRC-1.1** 

# 143' - 6" LEVEL 4 133' - 0" LEVEL 3 111' - 8" EVEL P1 89' - 0"

### **ZONING: EXTERIOR BUILDING MATERIAL & FINISH REQUIREMENTS**

- Exterior wall finish. Exterior wall surfaces of all buildings, excluding those
  portions of foundation walls extending normally above finished grade, shall be faced with glass, exterior cement plaster (stucco), natural stone, brick, architectural concrete (excluding tilt-up panel construction unless faced with code compliant material), metal in accordance with adopted policies and procedures set forth in the adopted resolution, or an equivalent or better. Except for glass or metal, all color shall be integral to the exterior wall finish material unless a colored and opaque coating for all or some part of the exterior wall finish material is specifically approved by the City Council as part of a development approval process and where the application has included:
- (A) Certification by the coating manufacturer that the coating is appropriate for the intended purpose and will not damage the exterior wall finish material to which it is to be applied; and
- (B) Certification by the exterior wall finish material manufacturer that the coating to be applied is one that is appropriate for the exterior wall finish material and that its use will not reduce or void the exterior wall finish material warranty.
- (2) Coating of exterior walls. No existing uncoated exterior wall finish material regulated by this section shall be coated after the effective date of this section except for the following.
- (A) As approved in subsections (f), (g), and (h) below: (B) Those portions of foundation walls above finished grade may be coated
- (C) Secondary materials as listed in subsection (c)(3) below may be coated
- (D) All exterior wall surfaces and secondary materials that were coated prior to the effective date of this section or allowed to be coated after that date by reason of the granting of development approval, administrative approval or a variance may be maintained, to include sealing and recoating, in a manner appropriate to that wall finish material or trim and consistent with that existing surface treatment or any prior approval by the issuing authority; and (E) Murals are counted as a secondary material. To protect the integrity and
- durability of exterior building materials, murals may not be applied directly to the surface of a building elevation. Murals may be applied to separate materials and attached to the building elevation. (3) Secondary materials. Up to 15% of the exterior wall surface of a building elevation may be secondary materials, such as, wood, metal, exterior insulation finish system (EIFS) or other equivalent material as approved by the issuing
- (4) Canopies and awnings. Up to 15% of the exterior wall surface of a building elevation may be covered by canopies and/or awnings intended to provide aesthetic embellishment, shade or weather protection. Exterior wall surface materials covered by canopies or awnings must meet the applicable requirements of this section and, depending on the wall surface material, count

### **20NING: ALTERNATIVE EXTERIOR MATERIALS ALLOWANCE**

§ 9.22 ALTERNATIVE EXTERIOR MATERIALS ALLOWANCE.

(a) To incentivize the construction of opportunity housing units affordable to households at or below 60% of AMI, a residential development that includes at least 9% of its total dwelling units affordable to households at or below 80% of AM may use the alternative exterior materials of fiber cement, engineered wood, exterior insulation finishing system (EIFS), and 20 year warranty metals on façades not facing public streets where otherwise not allowed by the city code as follows: (1) A development with 9% of its units qualifying as extremely low income affordable housing may cover up to 100% of qualifying façades with the listed alternative exterior materials;

(2) A development with 9% of its units qualifying as very low income affordable housing may cover up to 75% of qualifying façades with the listed alternative exterior materials; or

(3) A development with 9% of its units qualifying as low income affordable housing may cover up to 50% of qualifying façades with the listed alternative exterior materials.

(b) The alternative exterior material allowances provided in this section are not cumulative. Each qualifying development is eligible for only one alternative construction material allowance of 50%, 75%, or 100% depending on the level of (Ord. 2019-16, passed 2-25-2019; Ord. 2021-1, passed 3-6-2021)

# Knox & American II

1801 American Blvd W Bloomington MN 55431



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Thereby certify that this plan, specification, or

report was prepared by me or under my direct

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under the laws of the State of Minnesota

Signature

Typed or Printed Name

License # Date

ORIGINAL ISSUE: 04/19/23 REVISIONS

Date

Description

223403

PROJECT NUMBER Author Checker DRAWN BY CHECKED BY

KEY PLAN

89' - 0"

Knox & American II

**BUILDING ELEVATIONS** 

**DRC-2.1** 



1 SOUTH ELEVATION\_DRC

EAST ELEVATION\_DRC

QRC-2.1 1/16" = 1'-0"

The south, east, and north building elevations are street facing and are not eligible for exterior materials incentives. The narrative identifies some flexibility may be south for the north building elevation. Please continue to communicate with

# Knox & American II

1801 American Blvd W Bloomington MN 55431



VIEW OF 80-1/2 STREETSCAPE LOOKING EAST



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ORIGINAL ISSUE: 04/24/23

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223403 PROJECT NUMBER

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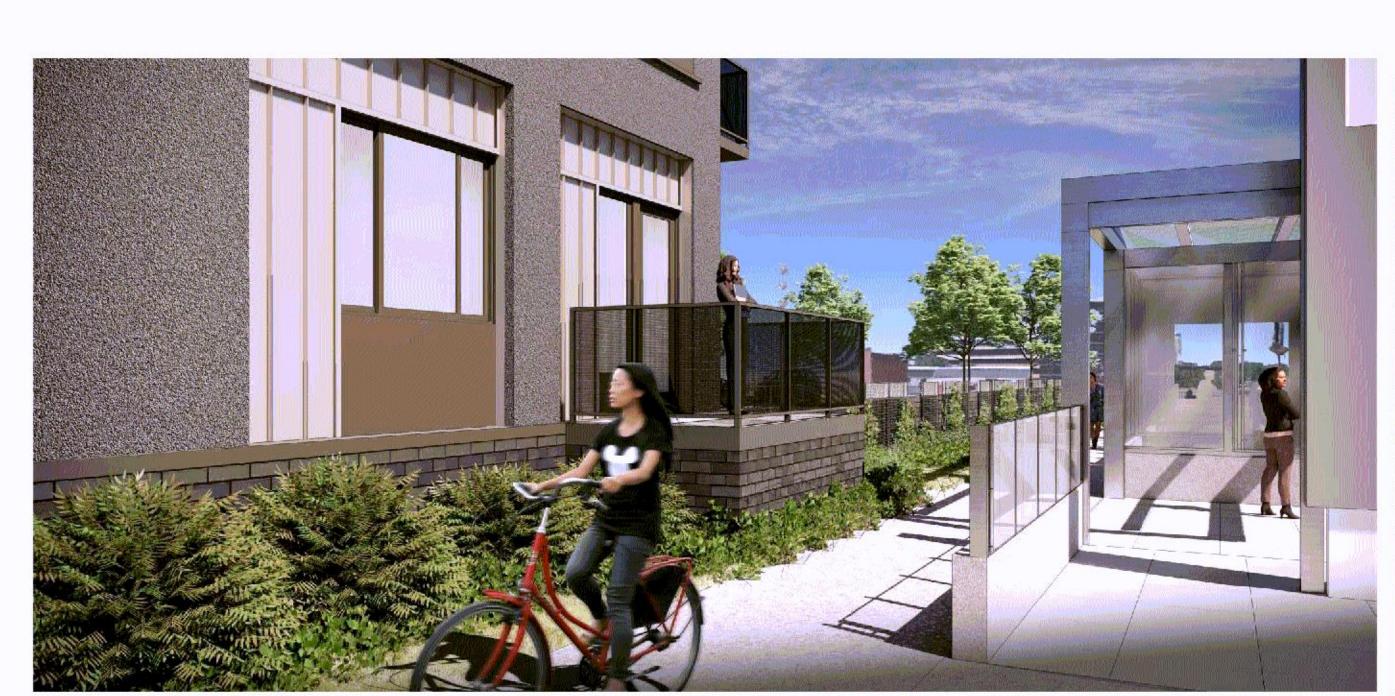
KEY PLAN

Knox &

American II

**3D VIEWS** 

**DRC-3.0** 








AERIAL VIEW OF 80-1/2 STREET FRONTAGE LOOKING NORTH

# KNOX & AMERICAN II

BLOOMINGTON, MINNESOTA ISSUED FOR: CITY SUBMITTAL

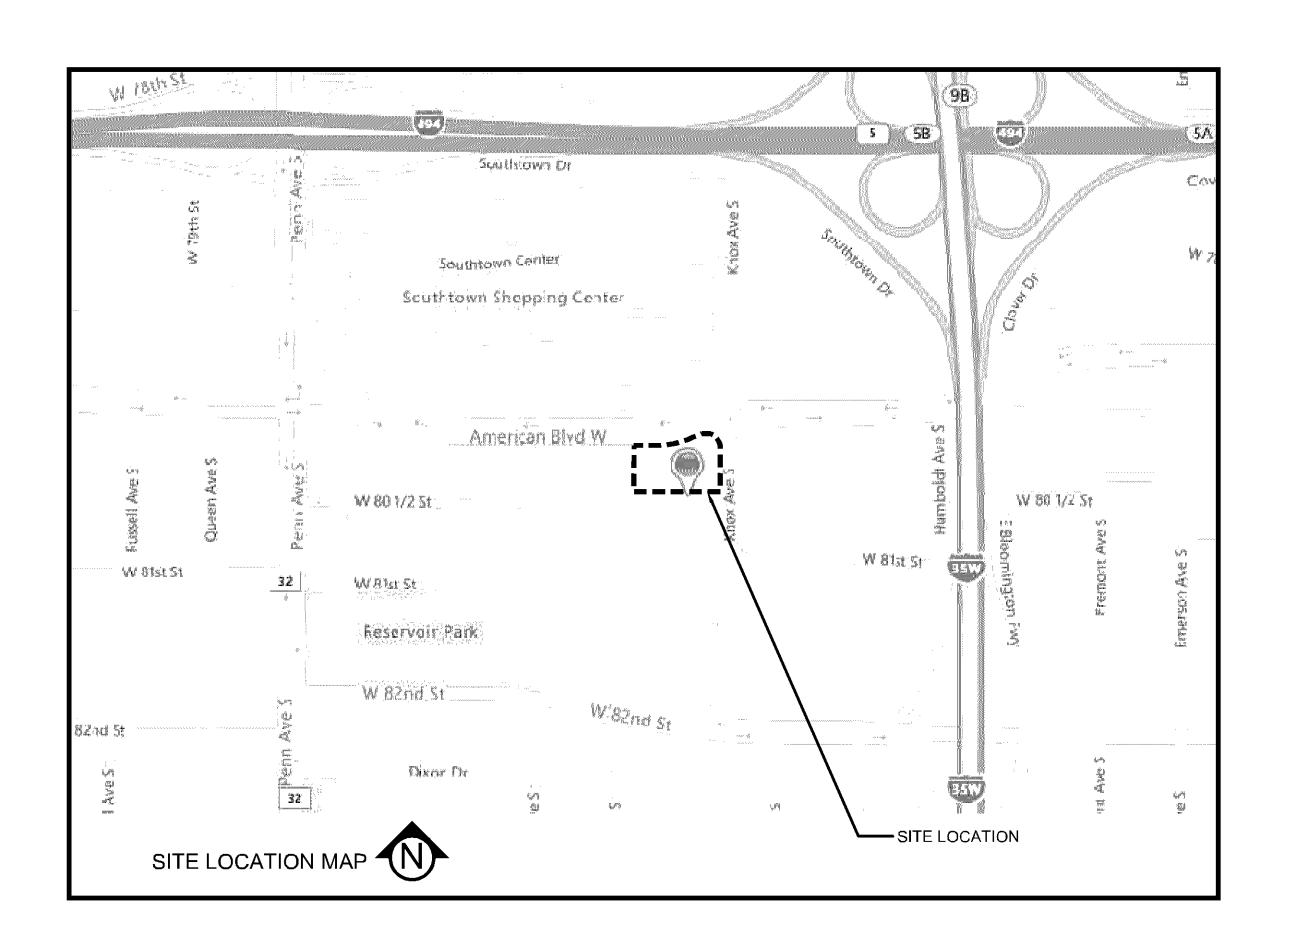

# ARCHITECT:

ESG ARCHITECTURE & DESIGN 500 WASHINGTON AVE S, SUITE 1080 MINNEAPOLIS, MN 55415 CONTACT: ARON THOMAS 612-268-2440

# DEVELOPER / PROPERTY OWNER:

STUART DEVELOPMENT CORPORATION 1000 W 80TH STREET MINNEAPOLIS, MN 55420 CONTACT: RYAN DUNLAY 952-948-9546

# ENGINEER / LANDSCAPE ARCHITECT:

CIVIL SITE GROUP
5000 GLENWOOD AVE
GOLDEN VALLEY, MN 55422
CIVIL ENGINEER CONTACT:
MATT PAVEK
612-615-0060 EXT 701
CIVIL SITE GROUP
5000 GLENWOOD AVE
GOLDEN VALLEY, MN 55422
LANDSCAPE ARCHITECT CONTACT:
BILL BROHMAN
612-615-0060 EXT 710

# SURVEYOR:

CIVIL SITE GROUP 5000 GLENWOOD AVE GOLDEN VALLEY, MN 55422 CONTACT: RORY SYNSTELIEN RORY@CIVILSITEGROUP.COM 612-615-0060

# GEOTECHNICAL ENGINEER:

BRAUN INTERTEC CORPORATION 11001 HAMPSHIRE AVE S MINNEAPOLIS, MN 55438 CONTACT: JOSEPH L. WESTPHAL 952-995-2000 ALL EXISTING UTILITY LOCATIONS SHOWN ARE
APPROXIMATE. CONTACT "GOPHER STATE ONE CALL"
(651-454-0002 OR 800-252-1166) FOR UTILITY LOCATIONS,
48 HOURS PRIOR TO CONSTRUCTION. THE
CONTRACTOR SHALL REPAIR OR REPLACE ANY UTILITIES
THAT ARE DAMAGED DURING CONSTRUCTION AT NO
COST TO THE OWNER.



# ARCHITECTURE & DESIGN ARCHITECTURE & DESIGN ARCHITECTURE & DESIGN

KNOX & AMER 8000 KNOX AVE S, BLOOMINGTON

I HEREBY CERTIFY THAT THIS PLAN,
SPECIFICATION, OR REPORT WAS
PREPARED BY ME OR UNDER MY DIRECT
SUPERVISION AND THAT I AM A DULY
LICENSED PROFESSIONAL ENGINEER
UNDER THE LAWS OF THE STATE OF
MINNESOTA.

Matthew R. Pavek

DATE 4-26-23 LICENSE NO. 44263

SHEET INDEX

SHEET NUMBER SHEET TITLE

C0.0 TITLE SHEET

V1.0 SITE SURVEY

C2.0 SITE PLAN

C1.0 REMOVALS PLAN

C3.0 GRADING PLAN

C4.0 UTILITY PLAN

C5.0 CIVIL DETAILS

C5.1 CIVIL DETAILS

C5.2 CIVIL DETAILS

L1.0 LANDSCAPE PLAN

SW1.2 SWPPP - DETAILS

SW1.3 | SWPPP - NARRATIVE

SW1.4 SWPPP - ATTACHMENTS

SW1.5 SWPPP - ATTACHMENTS

C1.1 TREE PRESERVATION PLAN

C2.2 SITE PLAN - EASEMENT EXHIBIT

L1.1 LANDSCAPE PLAN NOTES & DETAILS

SW1.0 SWPPP - EXISTING CONDITIONS

SW1.1 SWPPP - PROPOSED CONDITIONS

C2.1 SITE PLAN - TURNING MOVEMENT EXHIBIT

DRAWN BY:JR, BB REVIEWED BY: MP
PROJECT NUMBER: 23027


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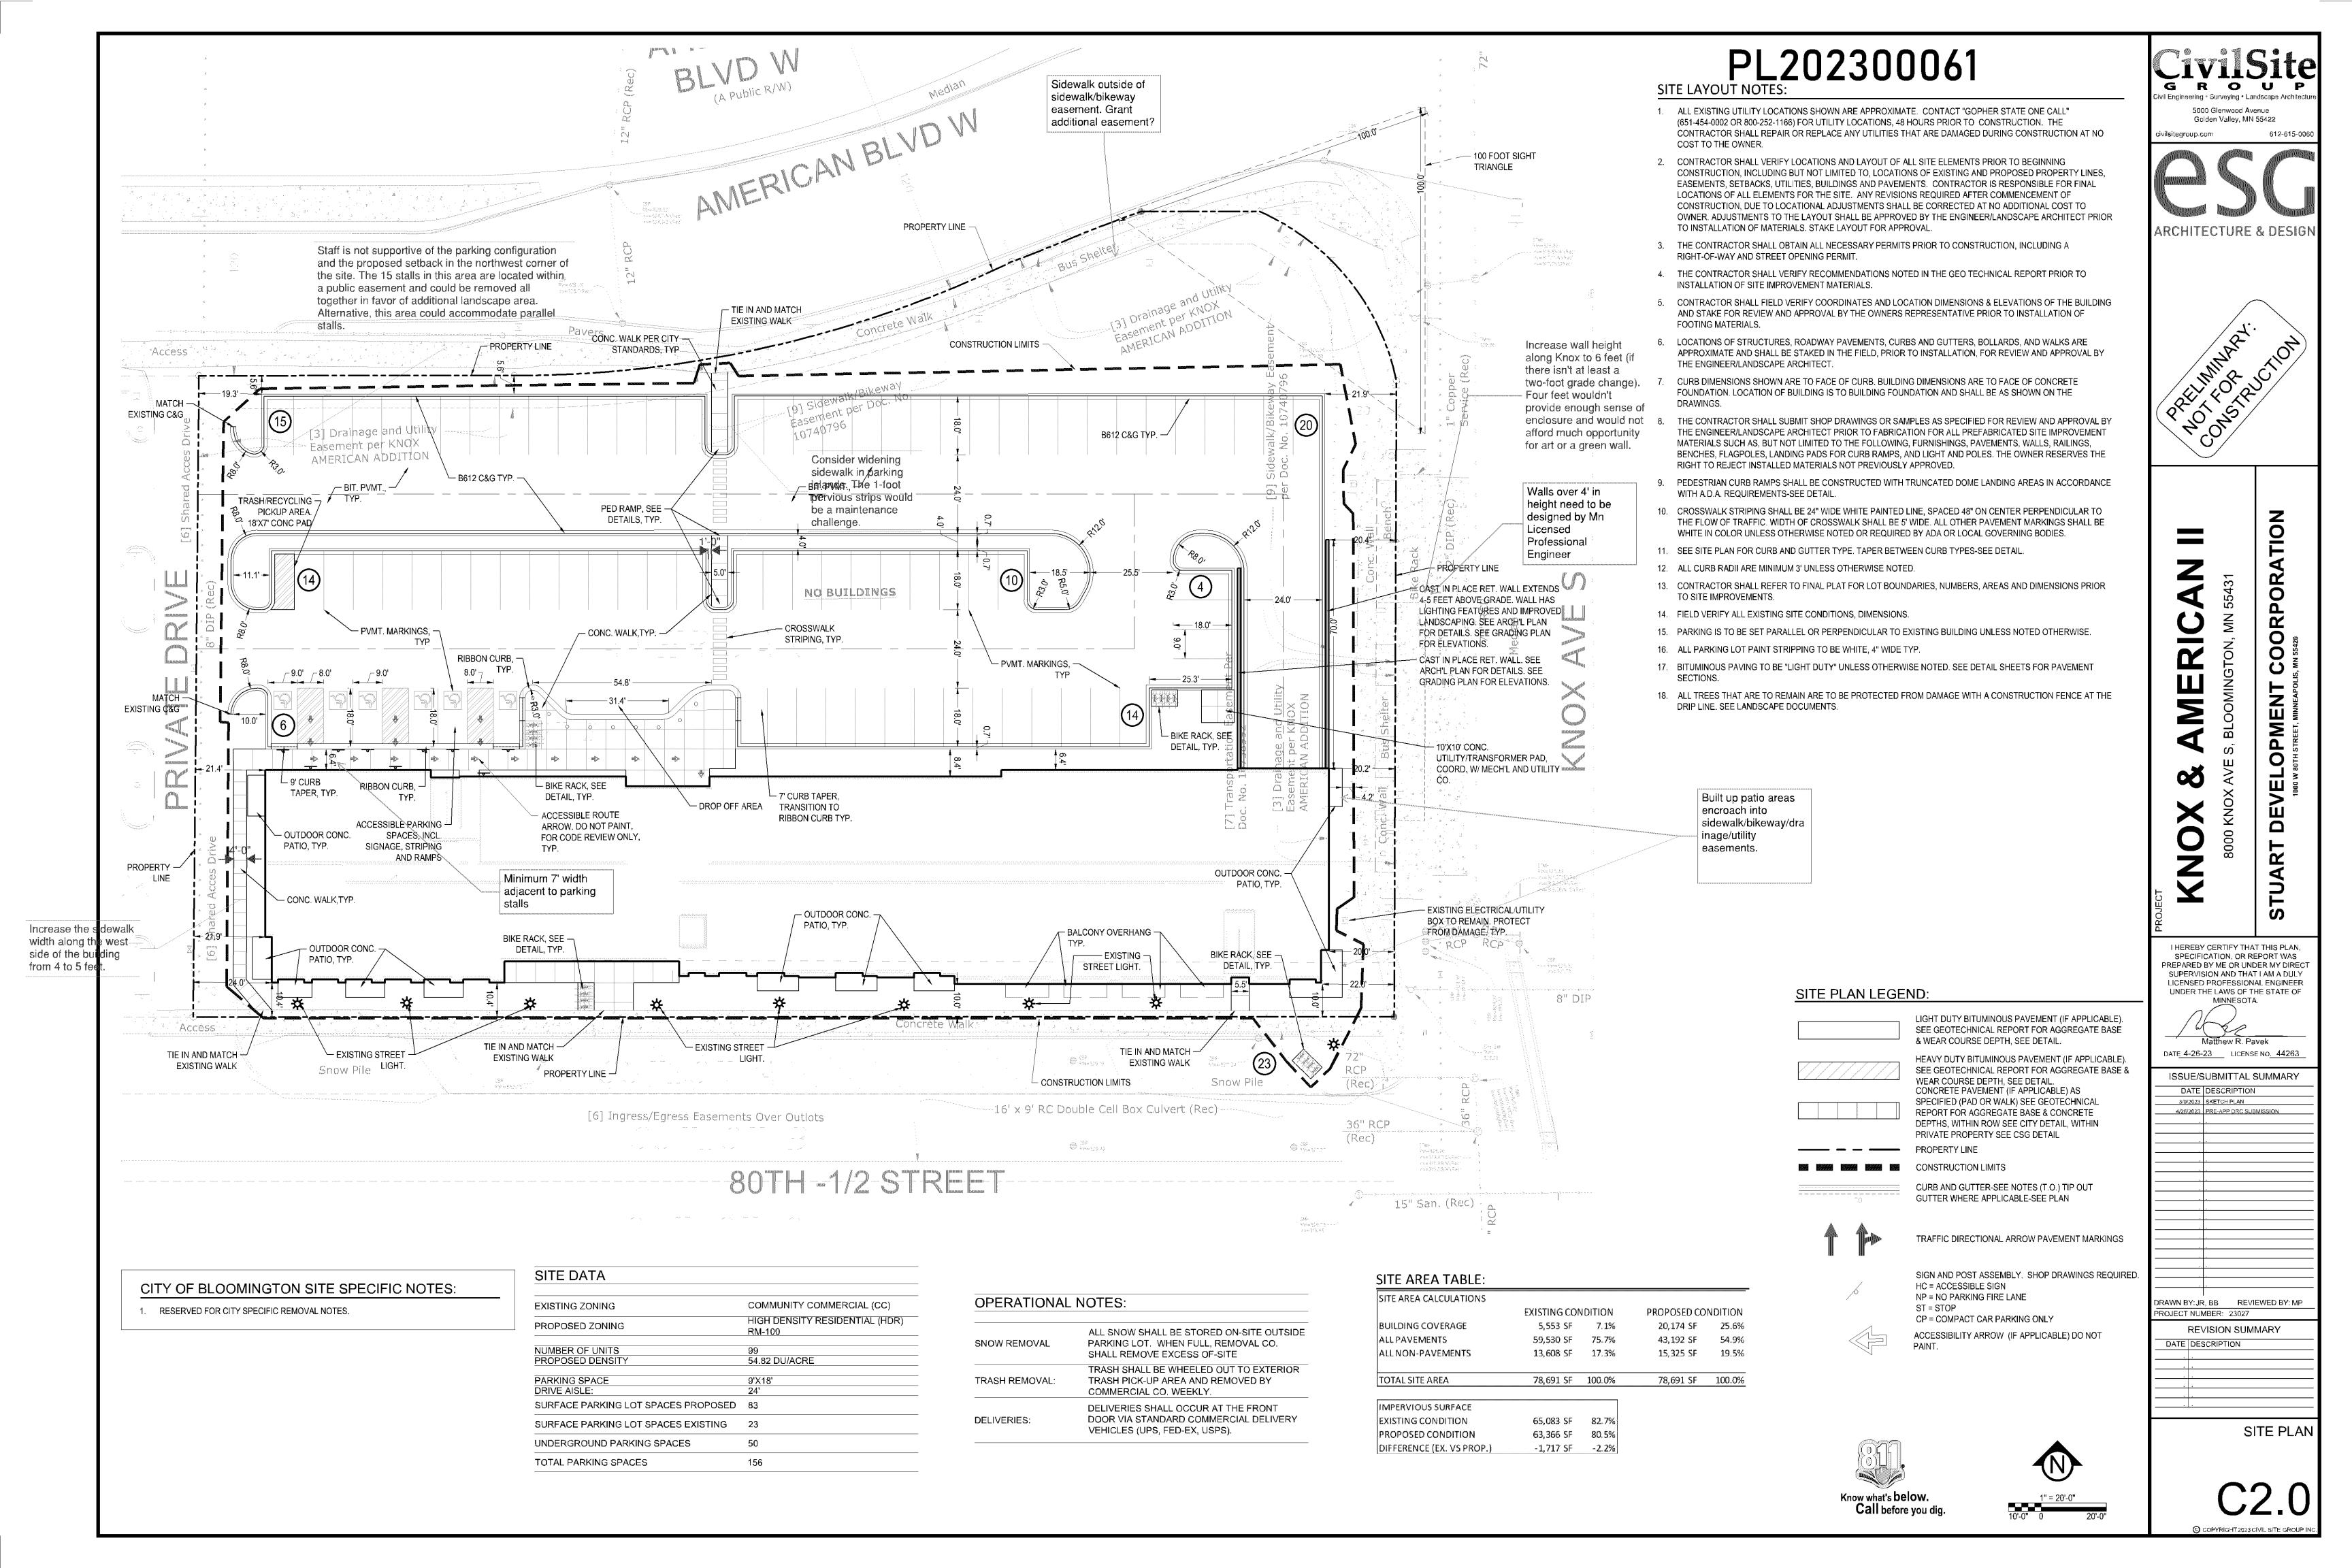
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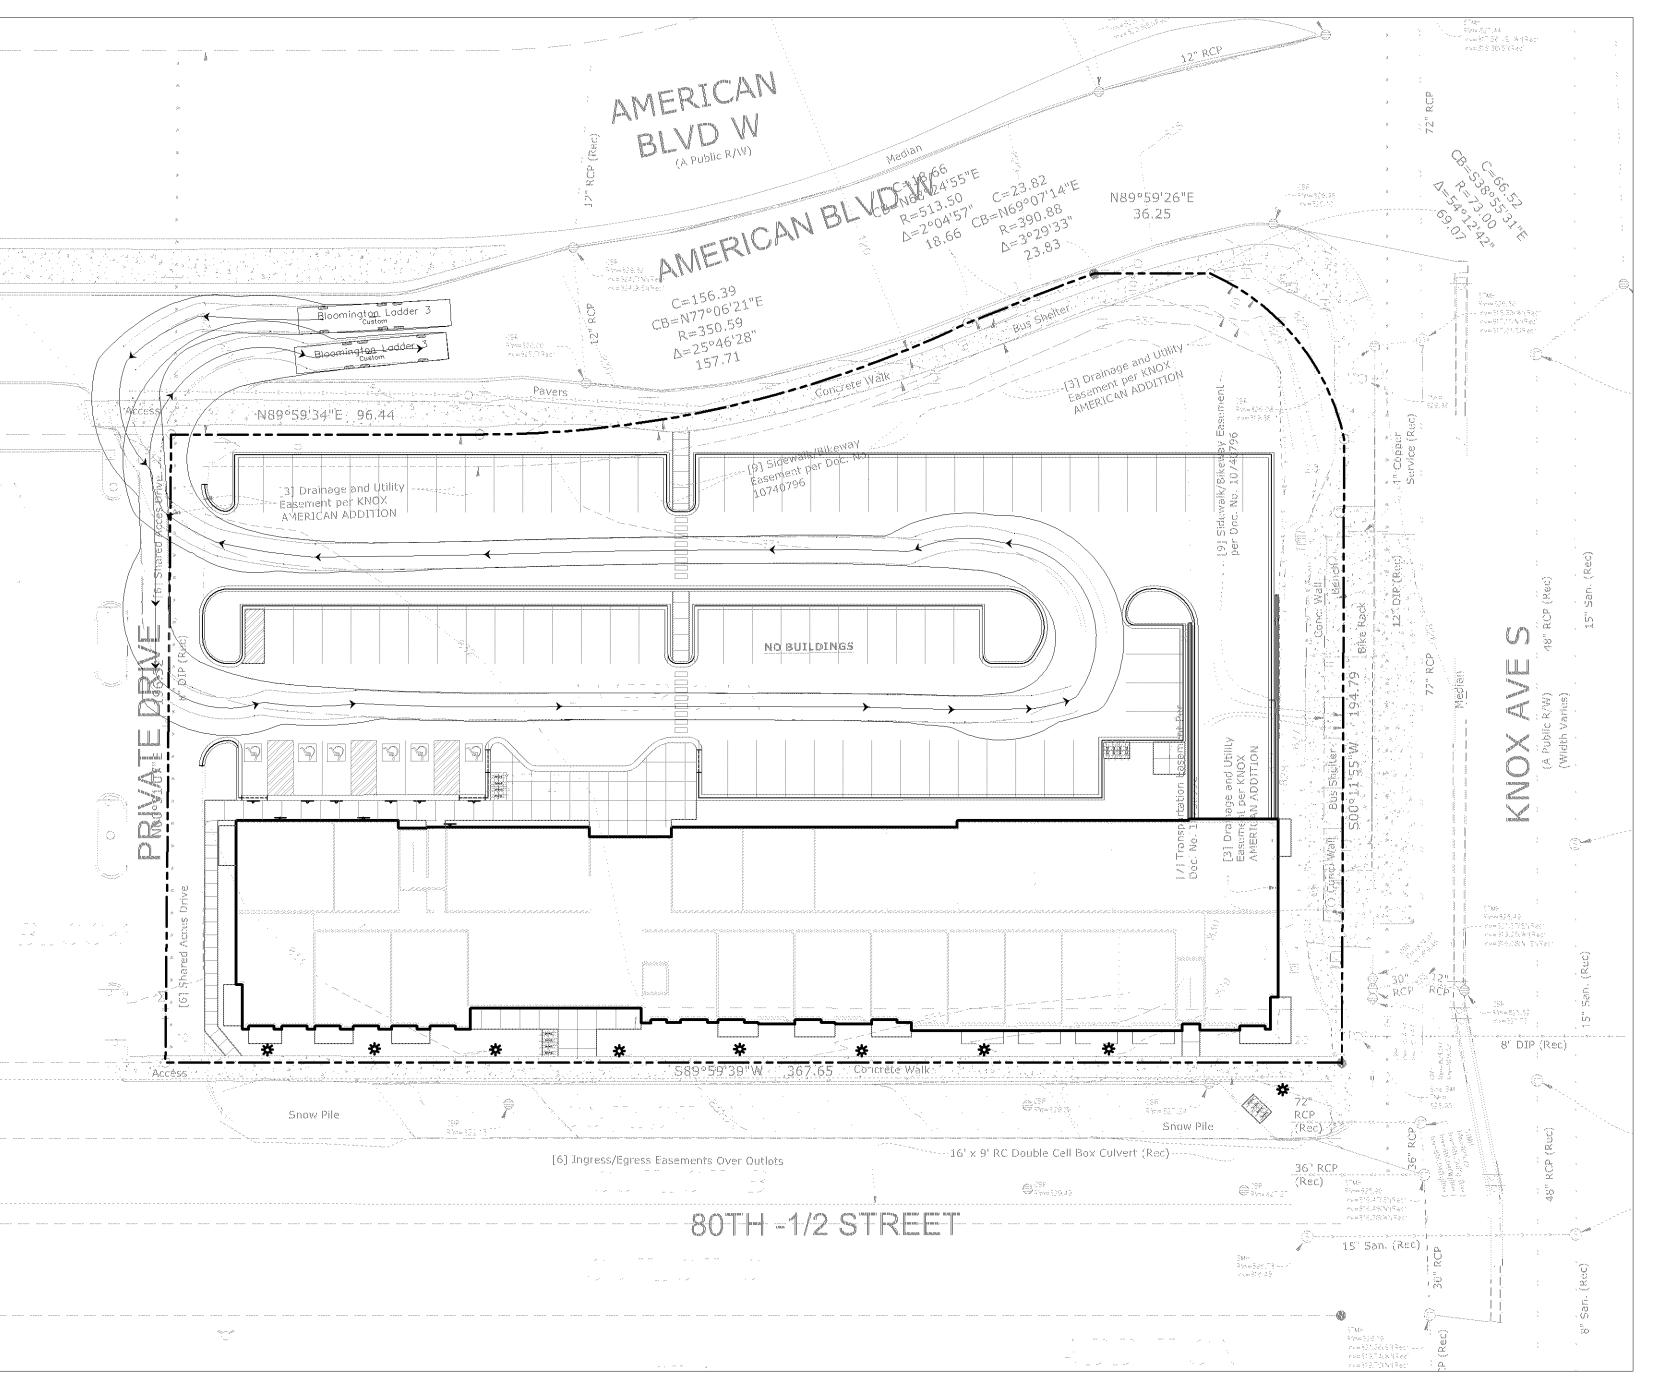
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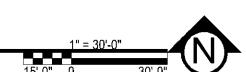
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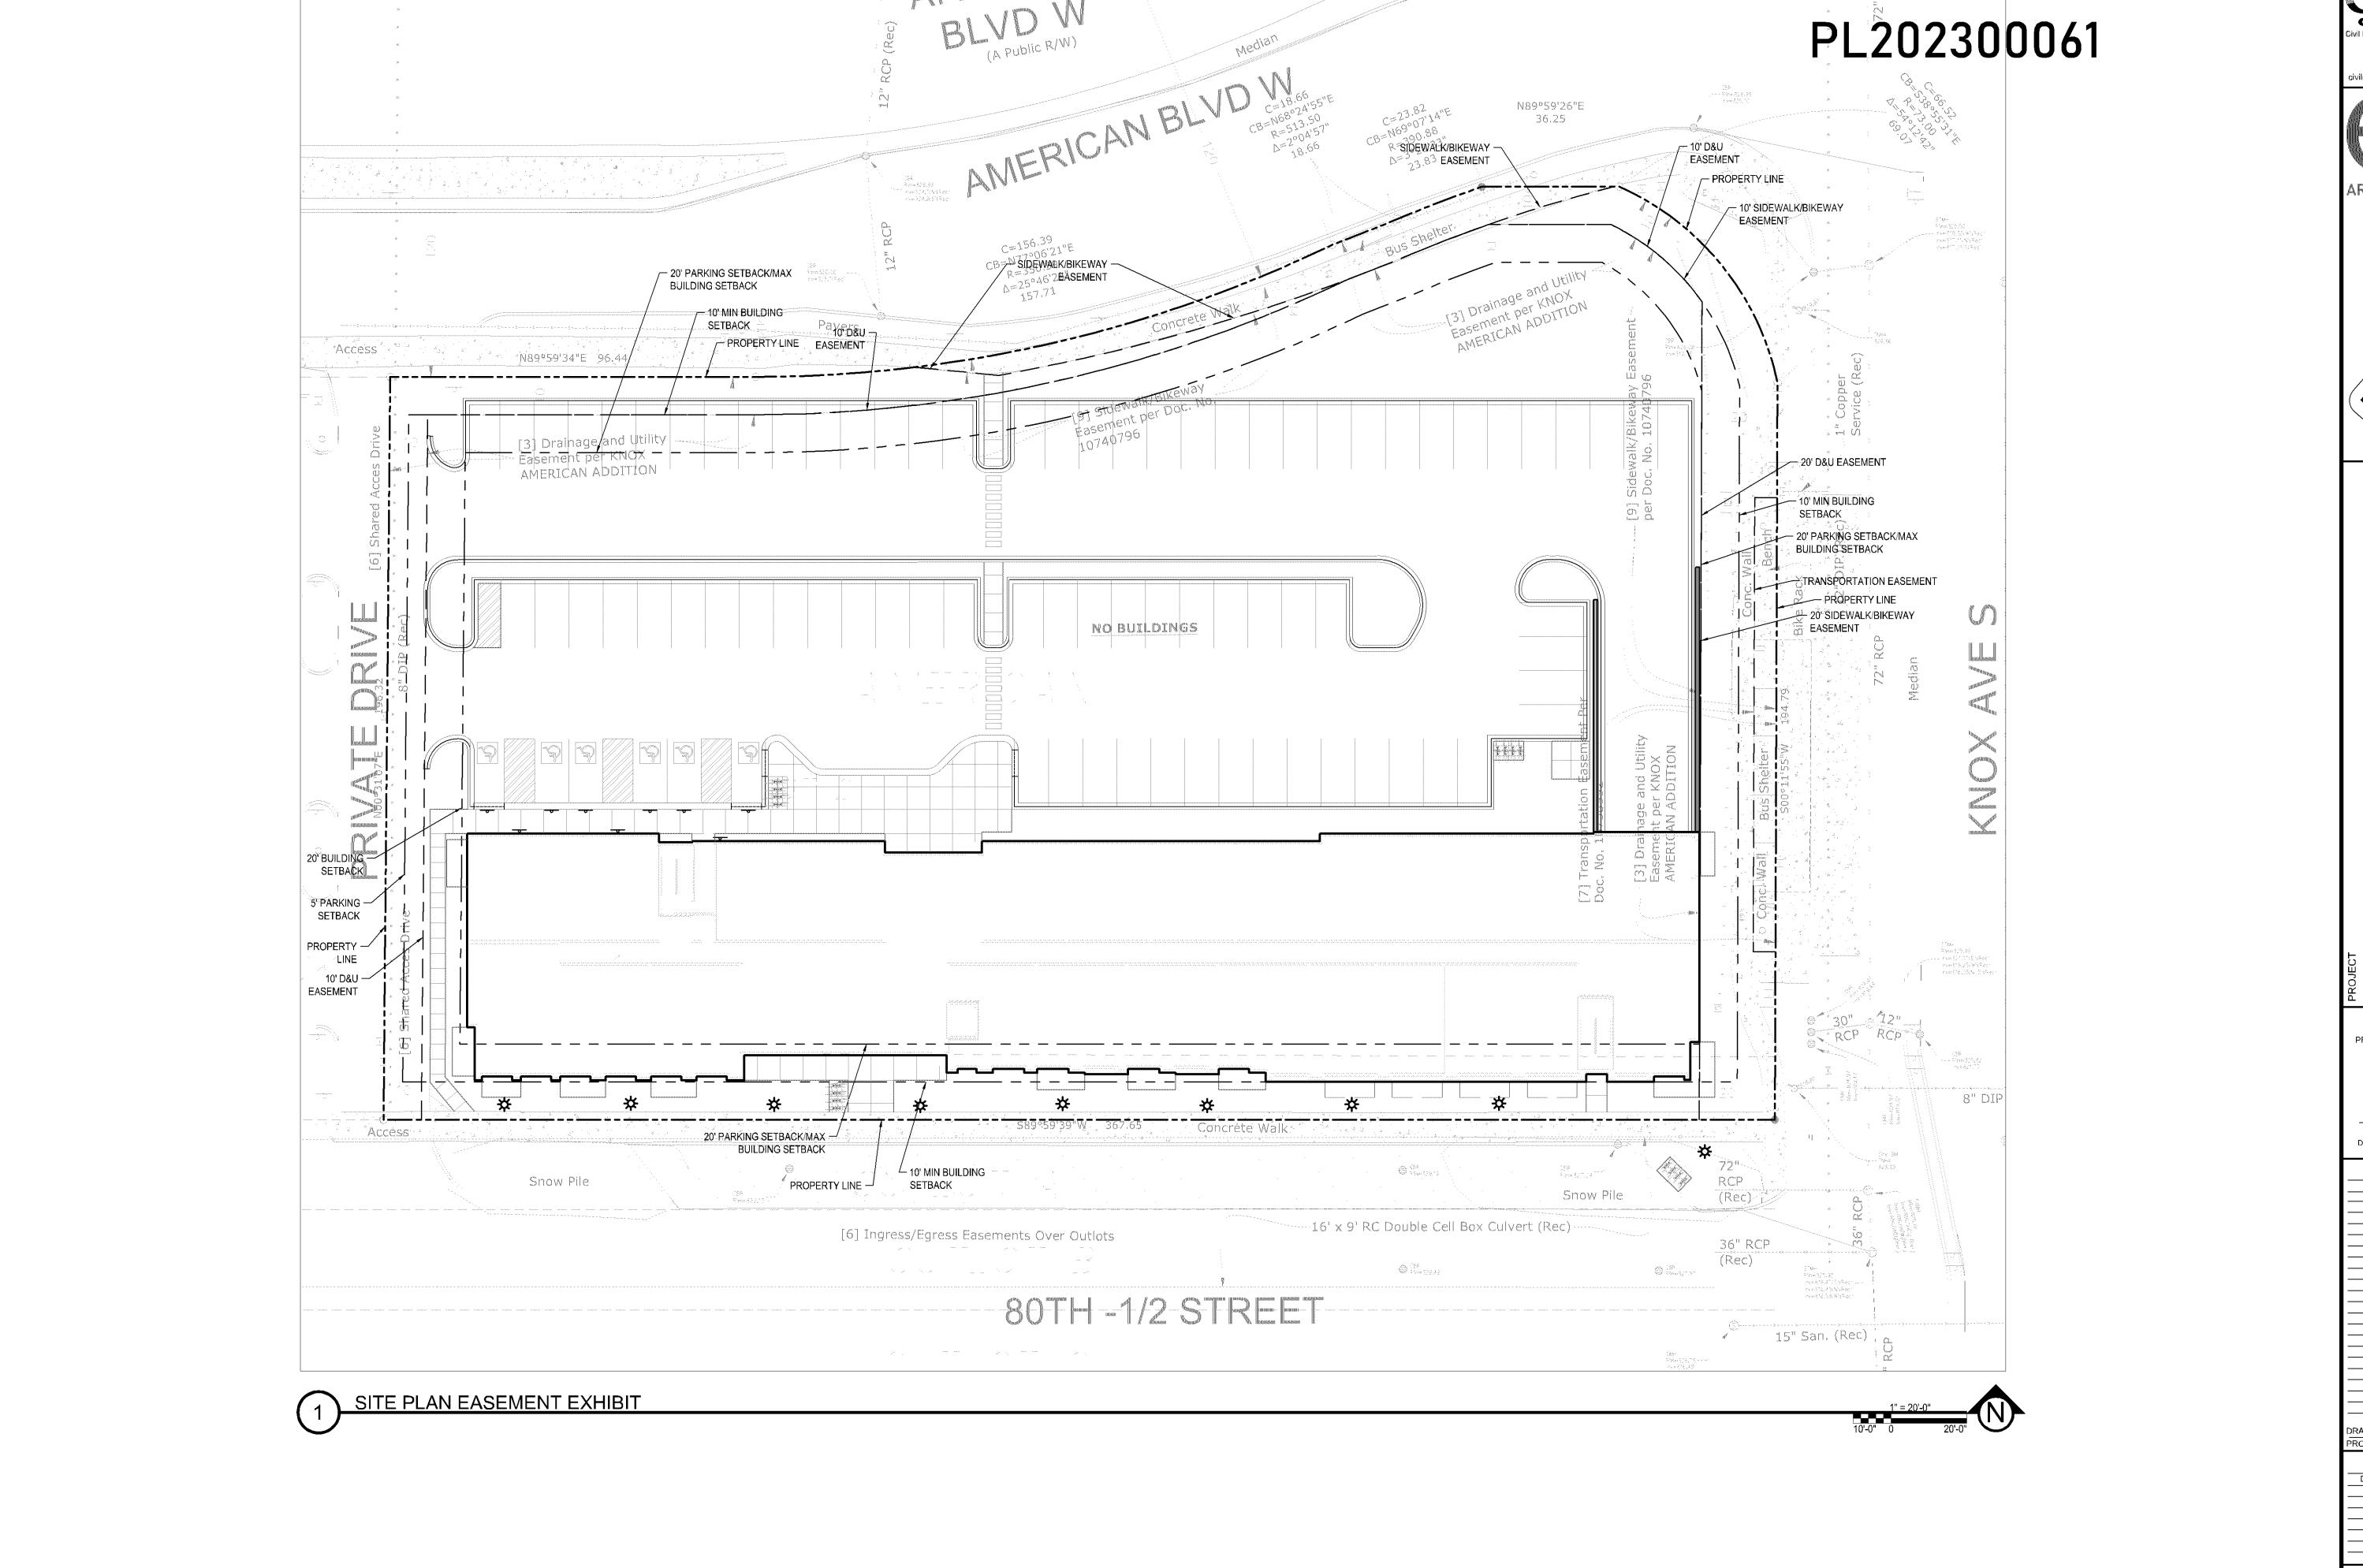
TURNING MOVEMENT EXHIBIT - FIRE TRUCK





MOVEMENT EXHIBIT



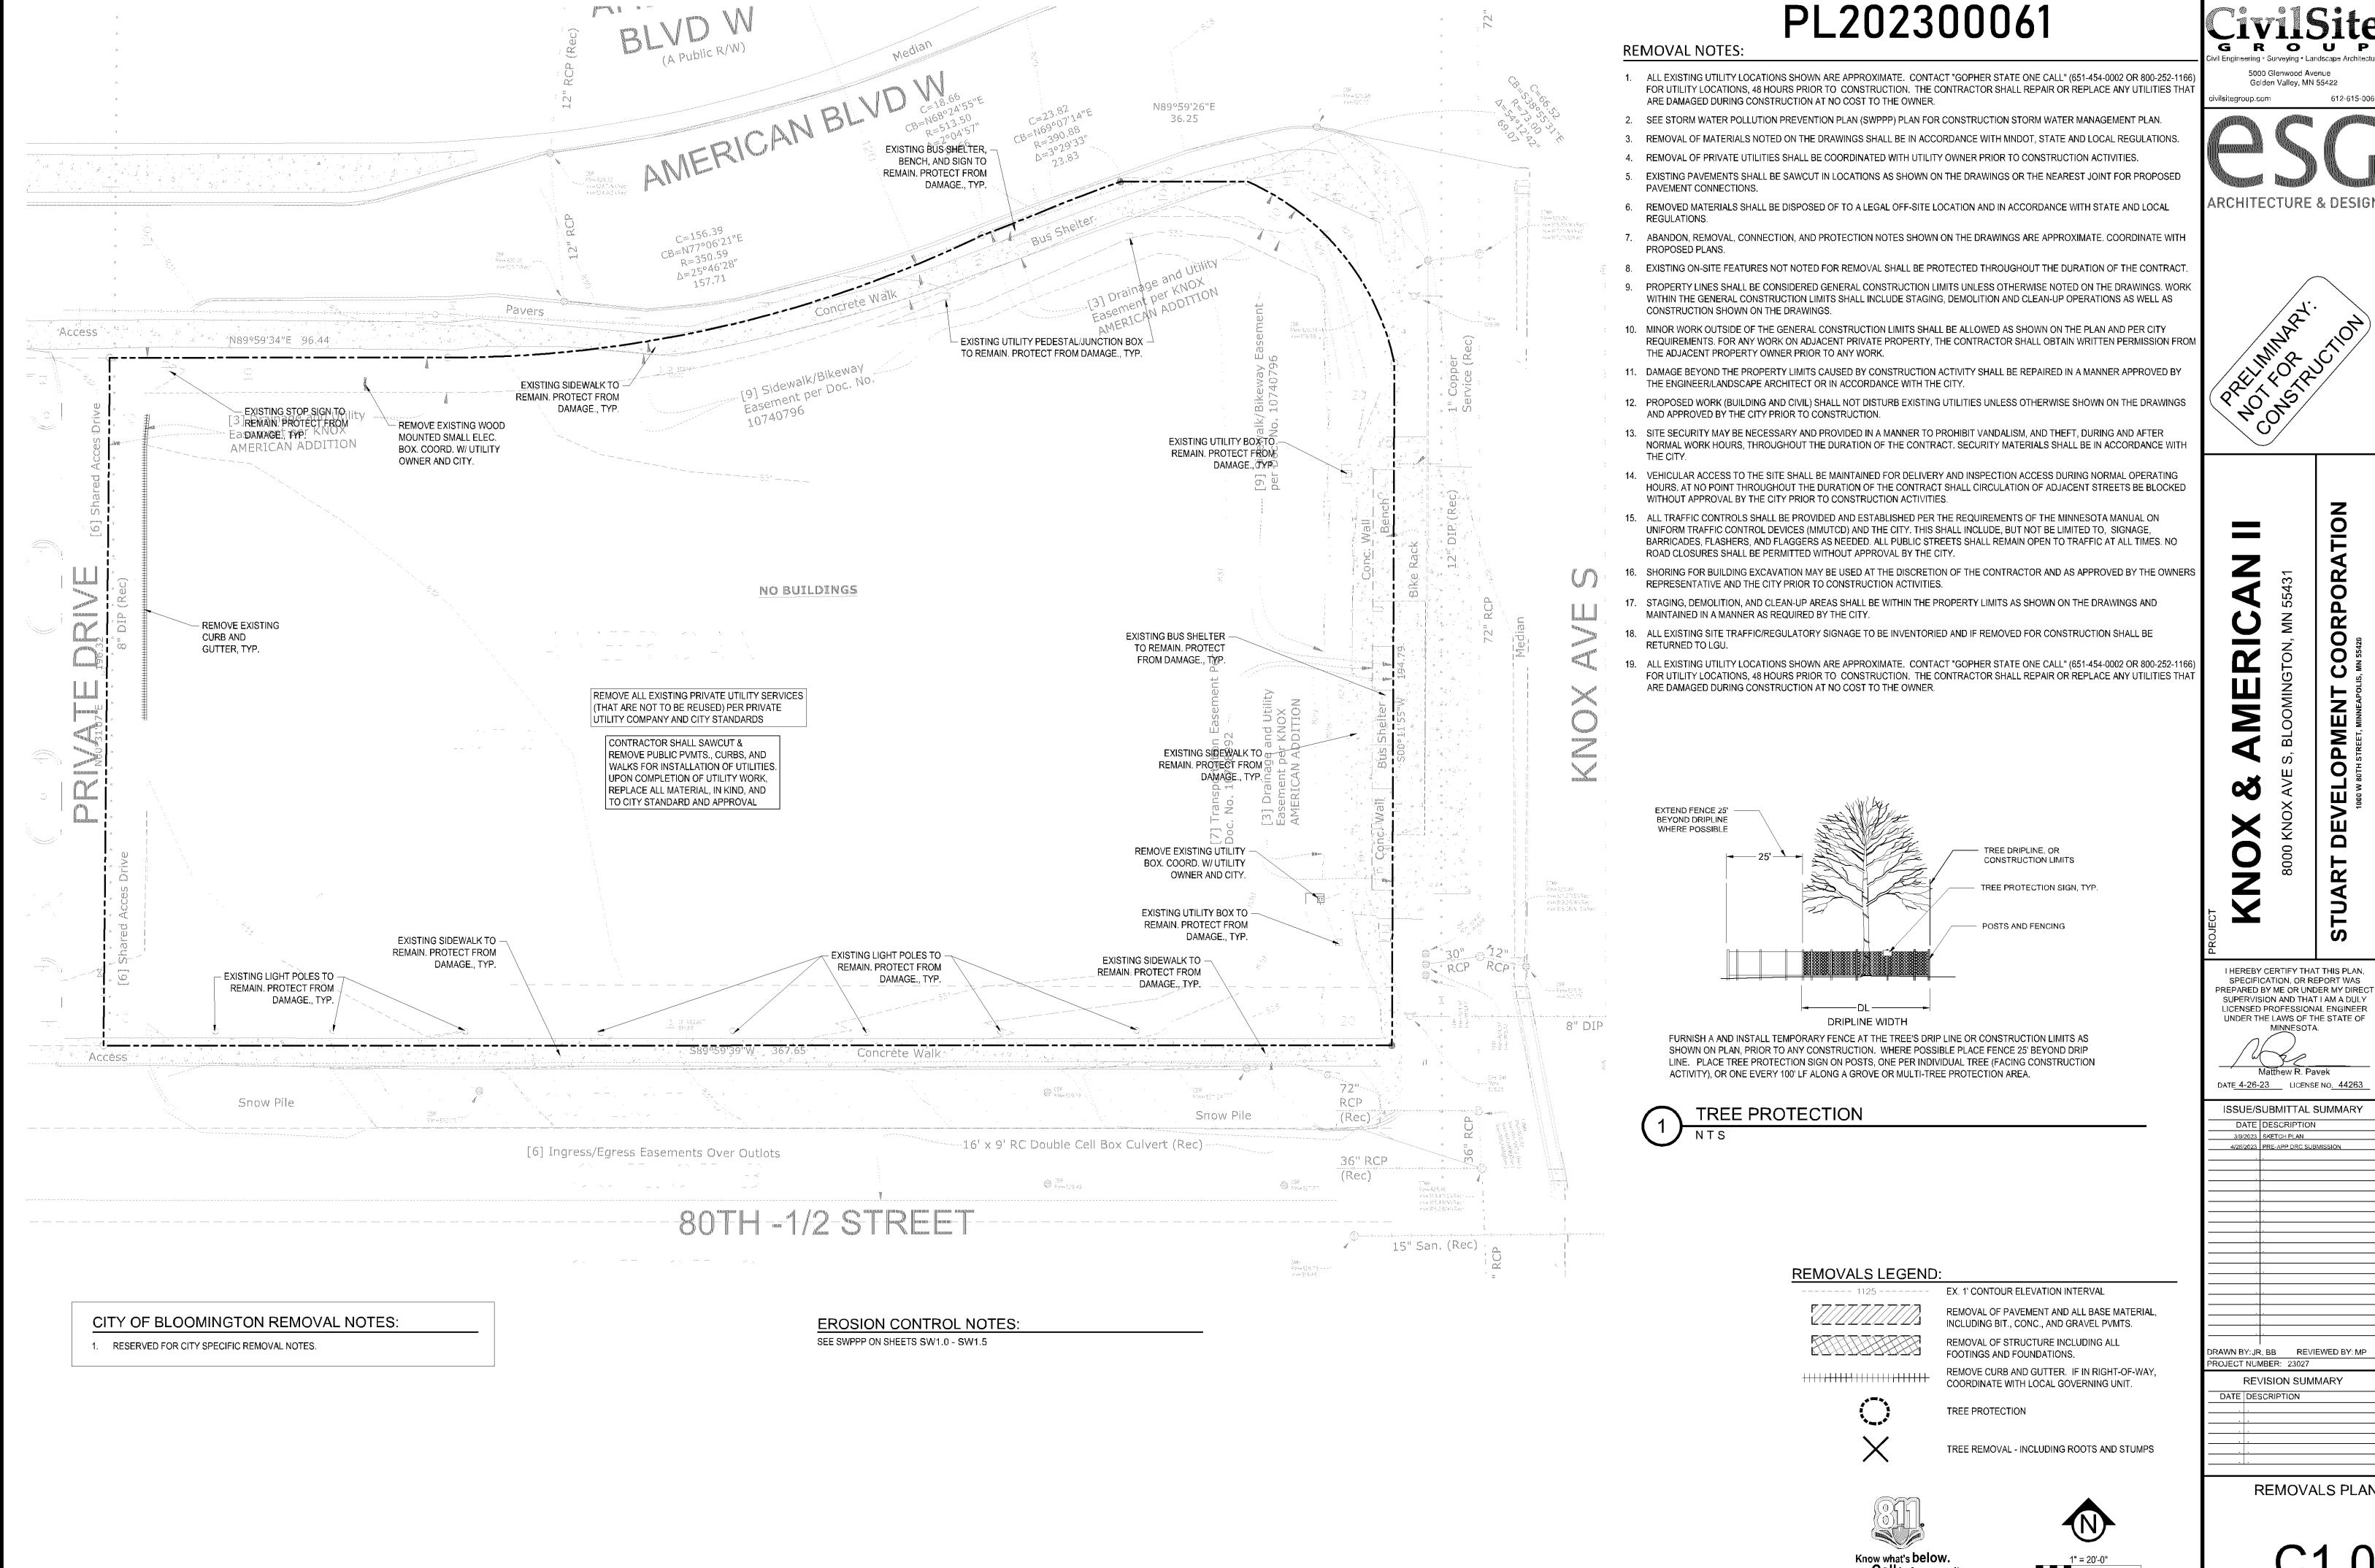


5000 Glenwood Avenue Golden Valley, MN 55422 ARCHITECTURE & DESIGN COORPORA AMERIC EVELOPMENT KNO 8000 KN I HEREBY CERTIFY THAT THIS PLAN, SPECIFICATION, OR REPORT WAS PREPARED BY ME OR UNDER MY DIRECT SUPERVISION AND THAT I AM A DULY LICENSED PROFESSIONAL ENGINEER UNDER THE LAWS OF THE STATE OF MINNESOTA. DATE 4-26-23 LICENSE NO. 44263 ISSUE/SUBMITTAL SUMMARY DATE DESCRIPTION 3/9/2023 SKETCH PLAN 4/26/2023 PRE-APP DRC SUBMISSION


DRAWN BY: JR, BB REVIEWED BY: MP
PROJECT NUMBER: 23027
REVISION SUMMARY

REVISION SUMMAR

SITE PLAN EASEMENT EXHIBIT

C2.2

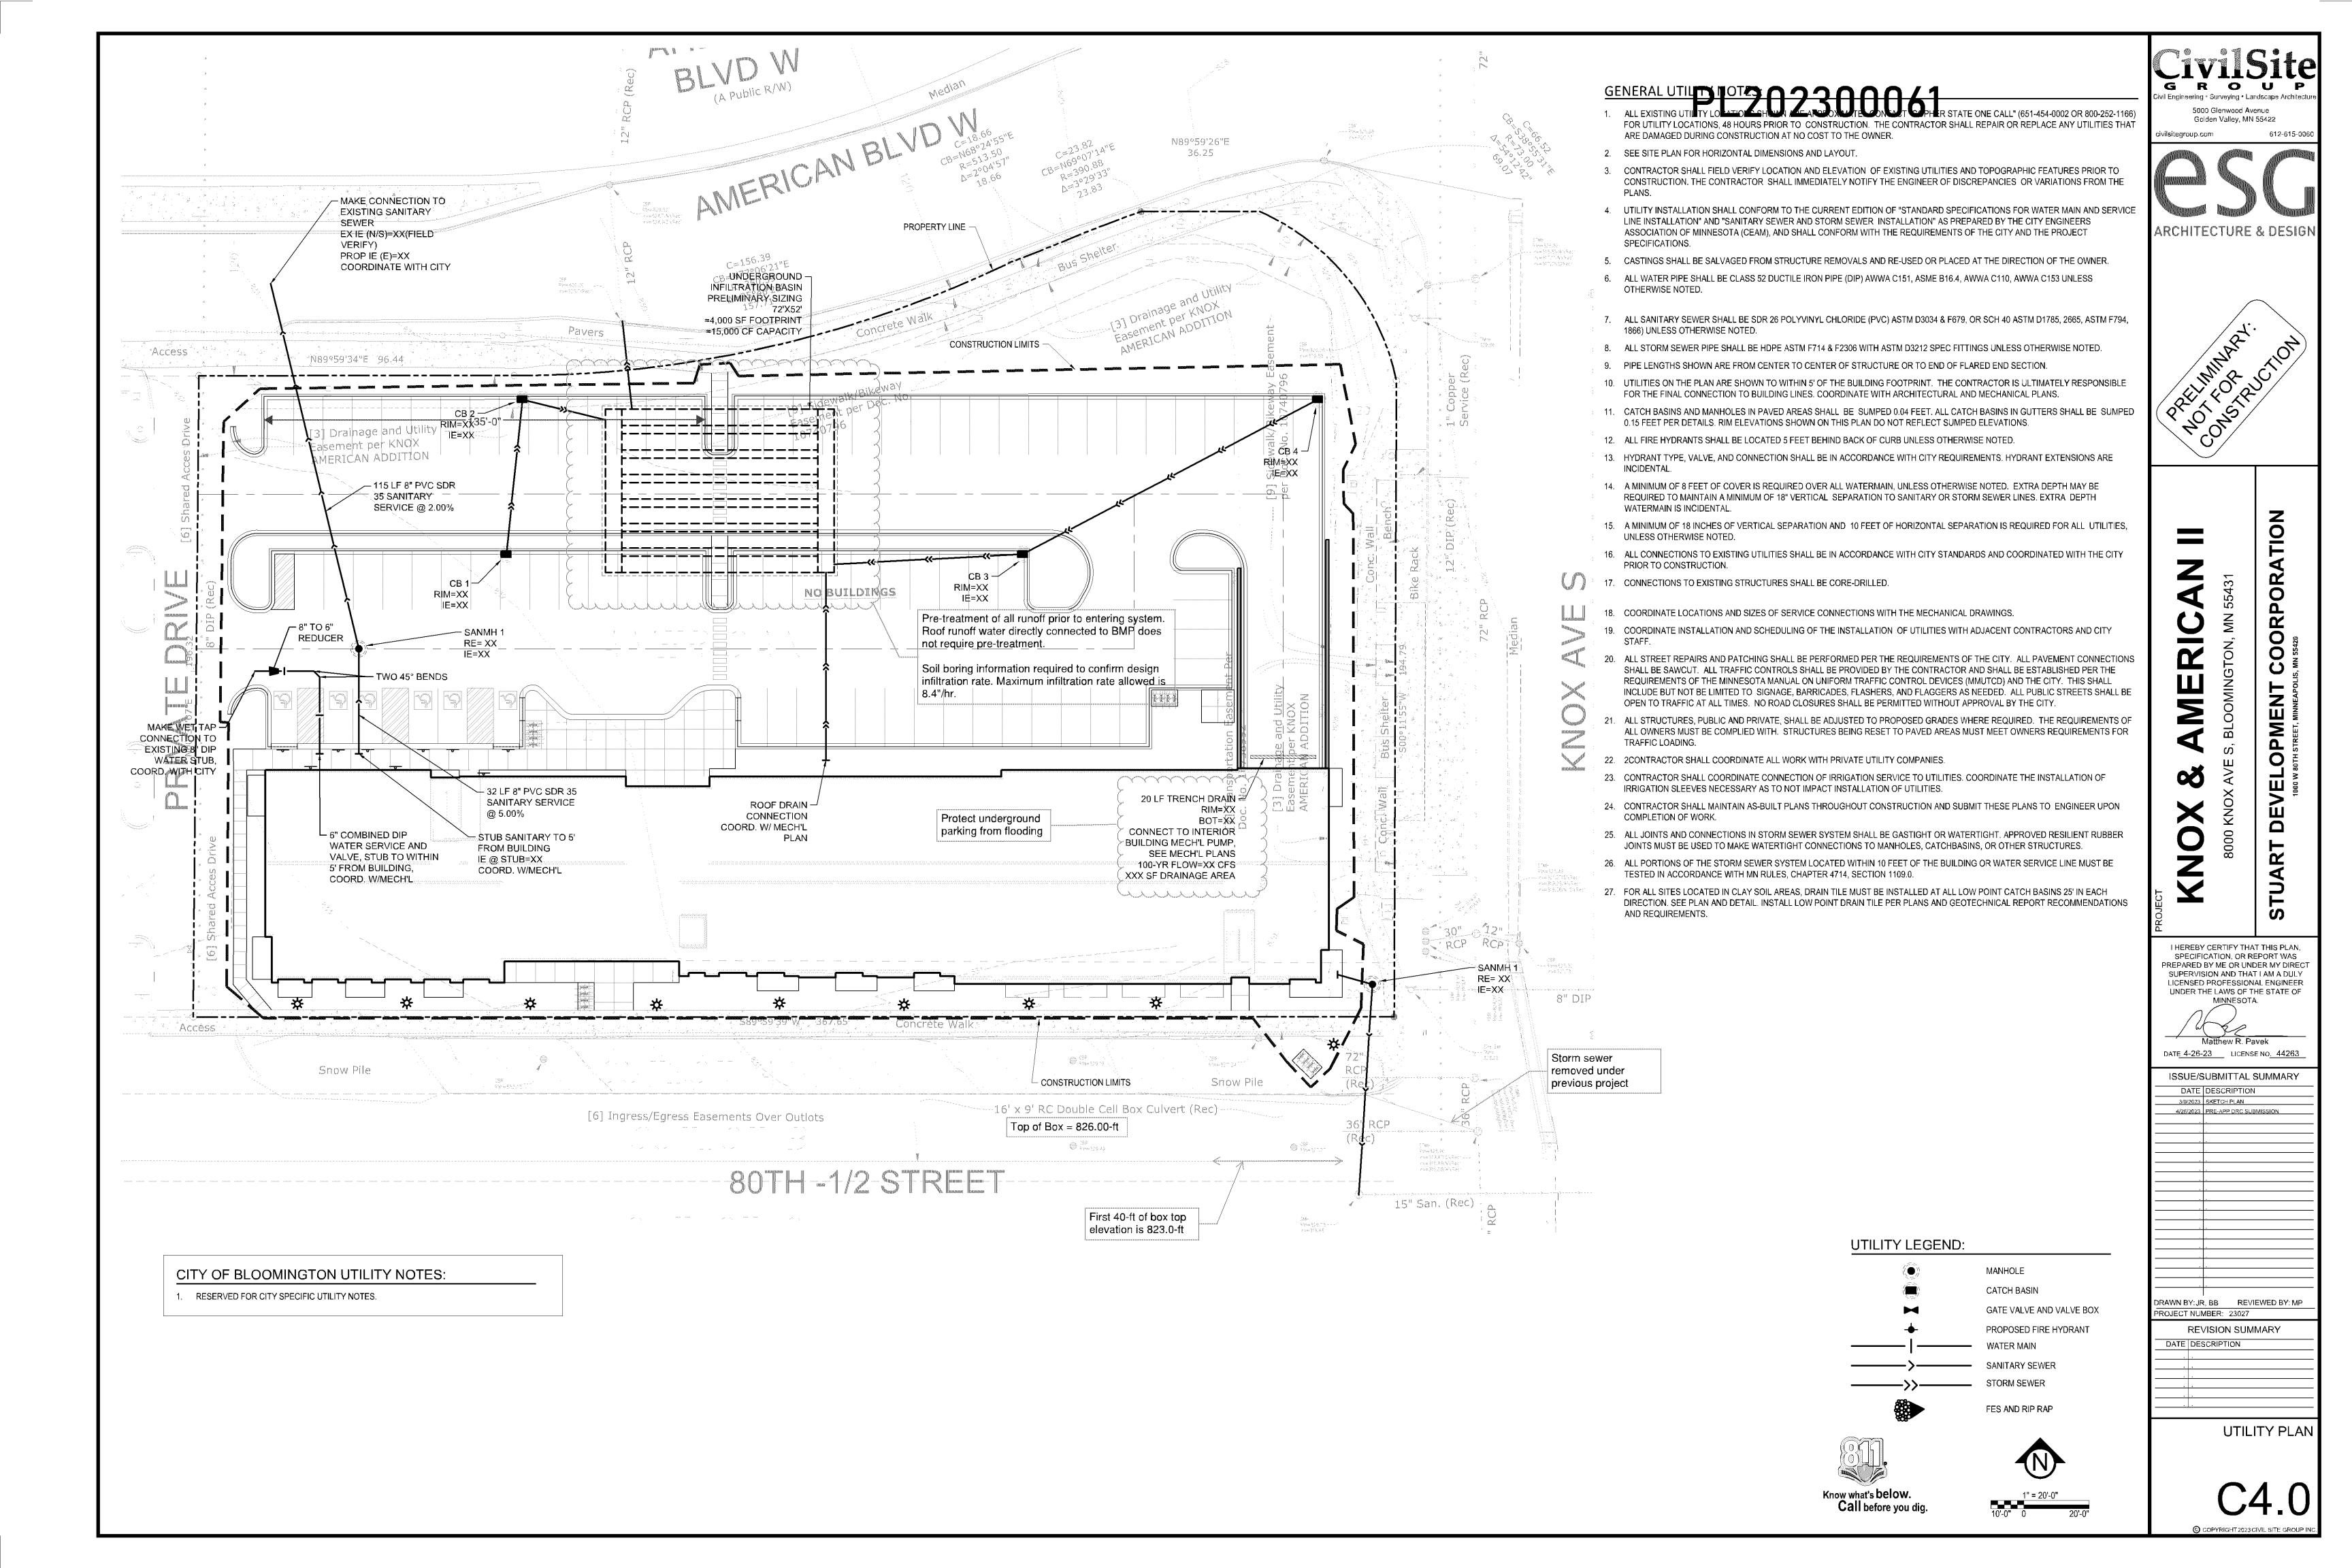

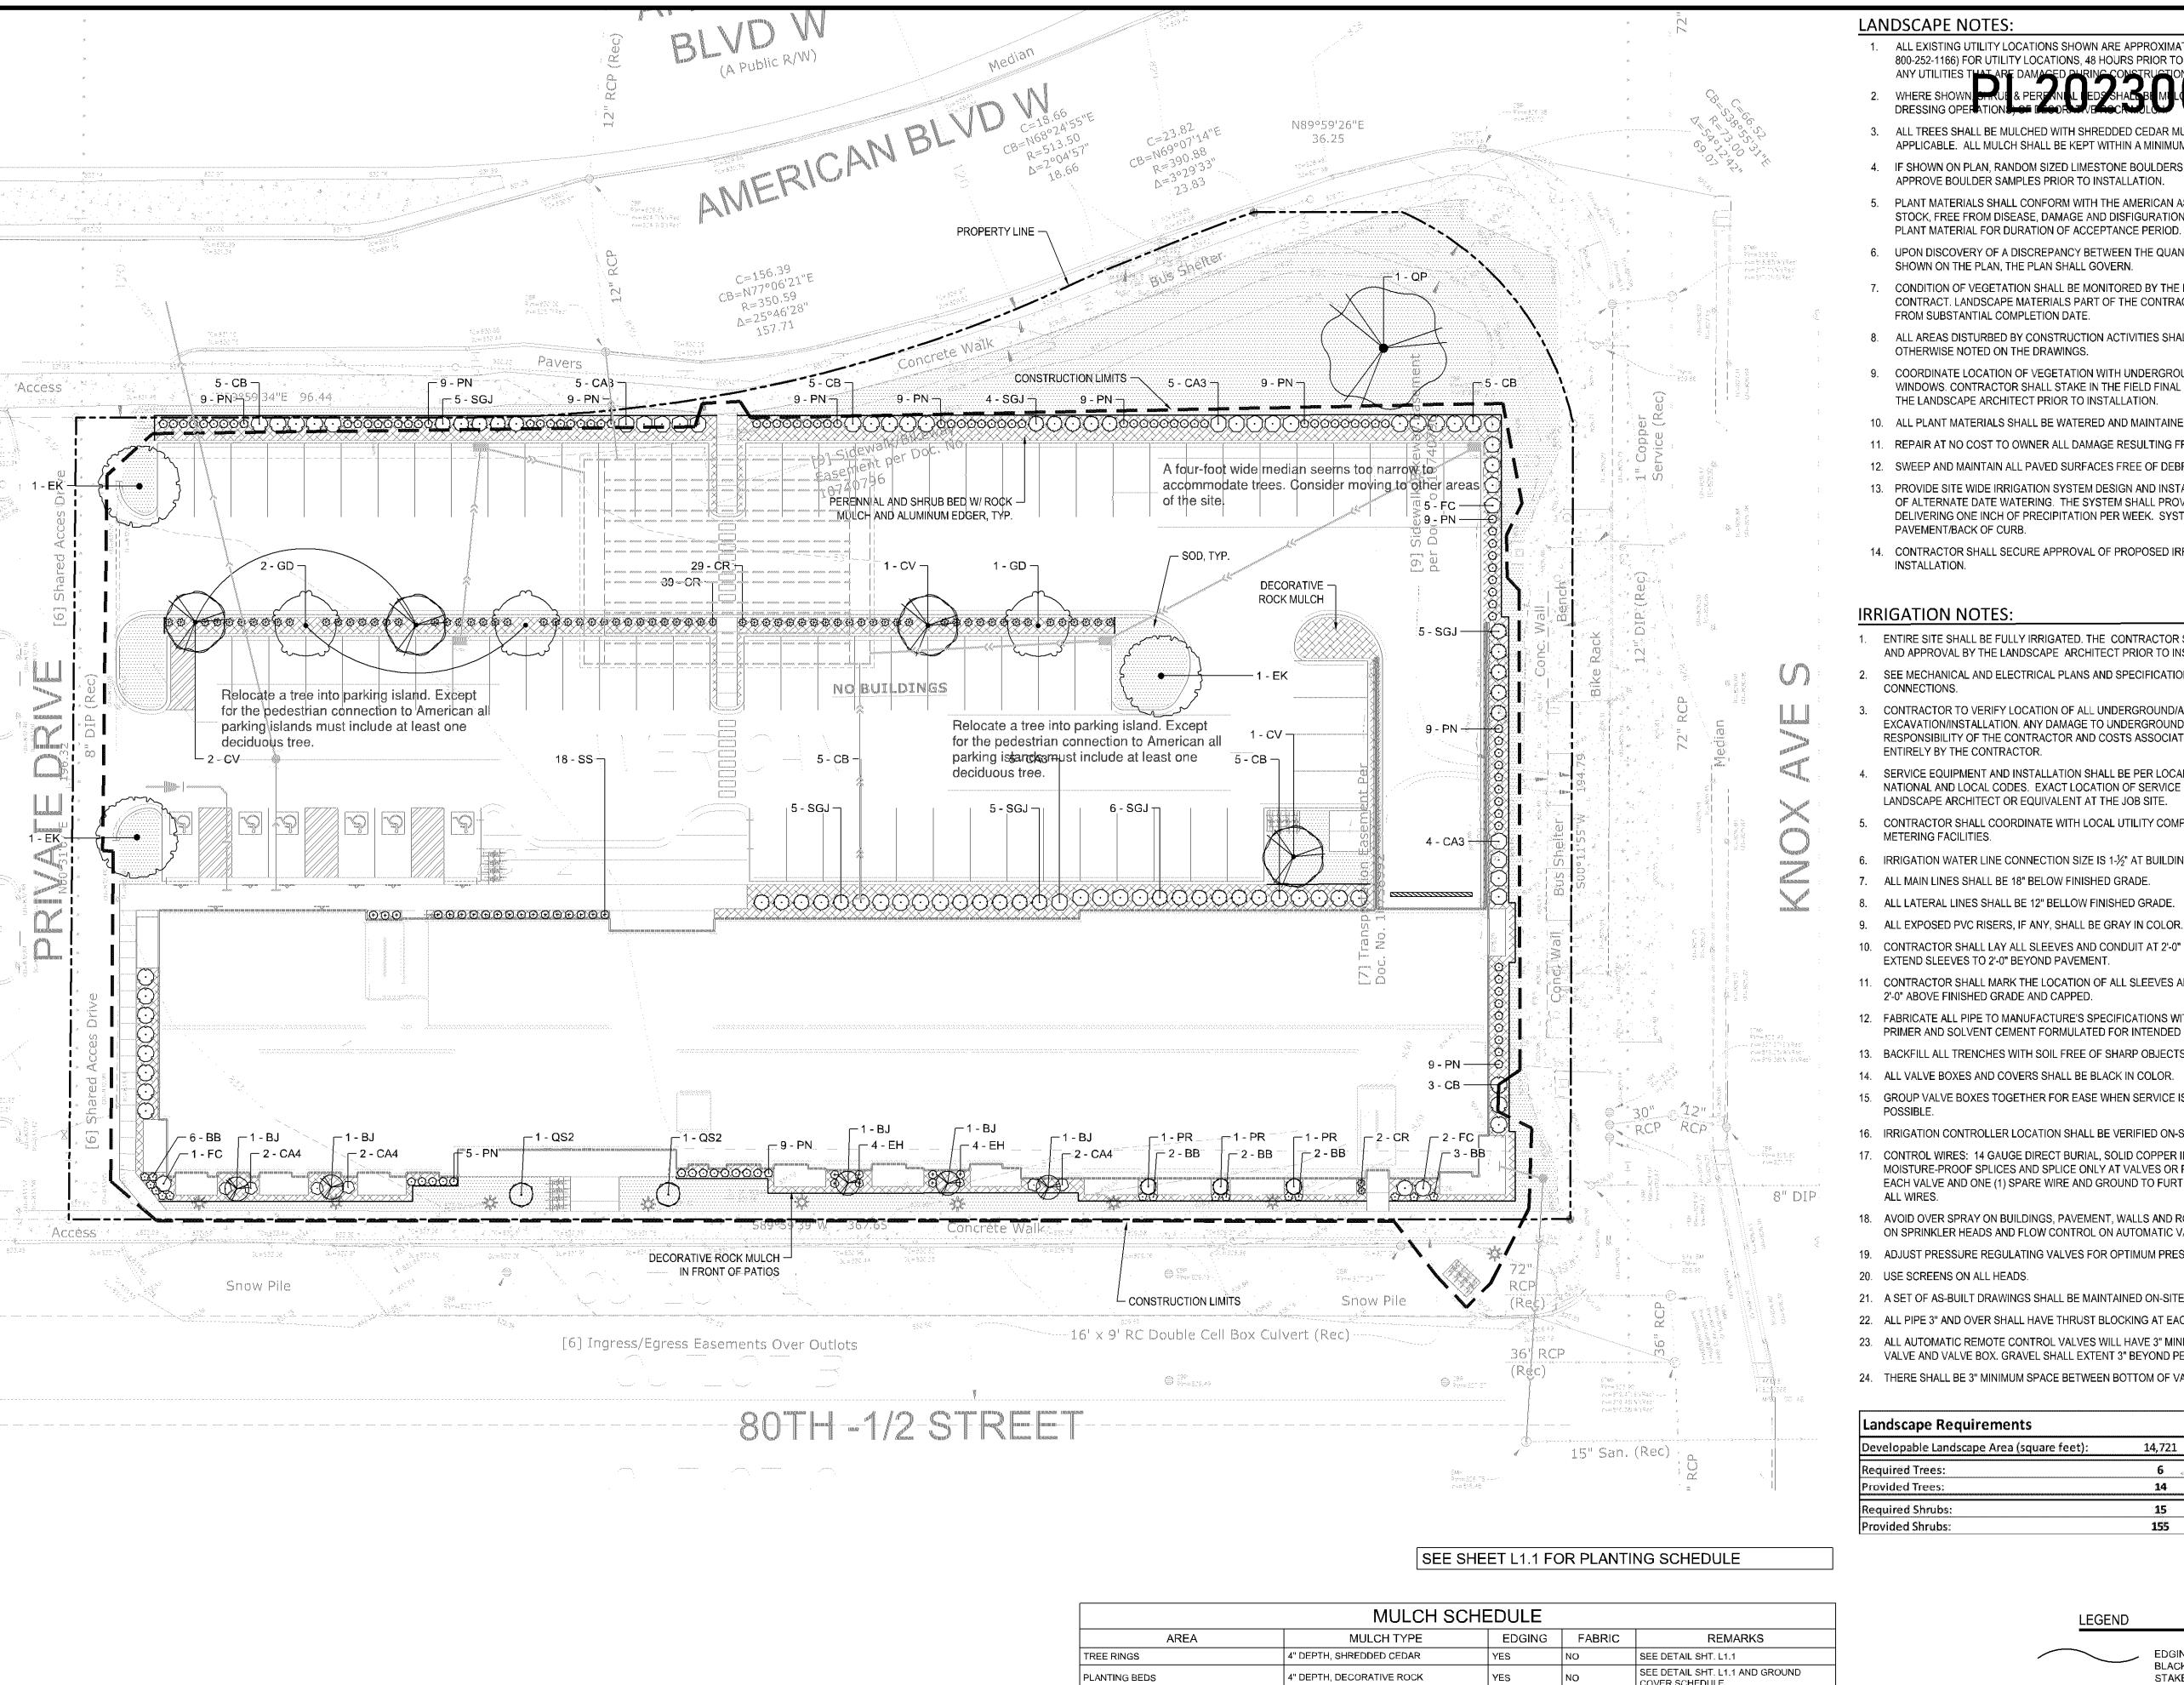

MULCH SCHEDULE							
AREA	MULCH TYPE	EDGING	FABRIC	REMARKS			
TREE RINGS	4" DEPTH, SHREDDED CEDAR	YES	NO	SEE DETAIL SHT. L1.1			
PLANTING BEDS	4" DEPTH, DECORATIVE ROCK	YES	NO	SEE DETAIL SHT. L1.1 AND GROUND COVER SCHEDULE			
MAINT. STRIP AT BUILDING FOUNDATION	NA	NA	NA				
DOG PARK MULCH	NA	NA	NA				
NATIVE SEED AREAS	NA	NA	NA				
NOTE: COORDINATE ALL MULCH AND PLAN MATERIALS	TING BED MATERIAL PRIOR TO INSTALLATION	, PROVIDE SAMP	LES AND SHOP [	DRAWINGS/PHOTOS/DATA SHEETS OF ALL			

### **LANDSCAPE NOTES:**

- ALL EXISTING UTILITY LOCATIONS SHOWN ARE APPROXIMATE. CONTACT "GOPHER STATE ONE CALL" (651-454-0002 OR 800-252-1166) FOR UTILITY LOCATIONS, 48 HOURS PRIOR TO CONSTRUCTION. THE CONTRACTOR SHALL REPAIR OR REPLACE
- (MINIMUM AFTER INSTALLATION AND/OR TOP
- 3. ALL TREES SHALL BE MULCHED WITH SHREDDED CEDAR MULCH TO OUTER EDGE OF SAUCER OR TO EDGE OF PLANTING BED, IF APPLICABLE. ALL MULCH SHALL BE KEPT WITHIN A MINIMUM OF 2" FROM TREE TRUNK.
- 4. IF SHOWN ON PLAN, RANDOM SIZED LIMESTONE BOULDERS COLOR AND SIZE TO COMPLIMENT NEW LANDSCAPING. OWNER TO APPROVE BOULDER SAMPLES PRIOR TO INSTALLATION.
- 5. PLANT MATERIALS SHALL CONFORM WITH THE AMERICAN ASSOCIATION OF NURSERYMEN STANDARDS AND SHALL BE OF HARDY STOCK, FREE FROM DISEASE, DAMAGE AND DISFIGURATION. CONTRACTOR IS RESPONSIBLE FOR MAINTAINING PLUMPNESS OF
- 6. UPON DISCOVERY OF A DISCREPANCY BETWEEN THE QUANTITY OF PLANTS SHOWN ON THE SCHEDULE AND THE QUANTITY SHOWN ON THE PLAN, THE PLAN SHALL GOVERN.
- 7. CONDITION OF VEGETATION SHALL BE MONITORED BY THE LANDSCAPE ARCHITECT THROUGHOUT THE DURATION OF THE CONTRACT. LANDSCAPE MATERIALS PART OF THE CONTRACT SHALL BE WARRANTED FOR TWO (2) FULL GROWING SEASONS FROM SUBSTANTIAL COMPLETION DATE.
- ALL AREAS DISTURBED BY CONSTRUCTION ACTIVITIES SHALL RECEIVE 6" LAYER TOPSOIL AND SOD AS SPECIFIED UNLESS OTHERWISE NOTED ON THE DRAWINGS.
- 9. COORDINATE LOCATION OF VEGETATION WITH UNDERGROUND AND OVERHEAD UTILITIES, LIGHTING FIXTURES, DOORS AND WINDOWS. CONTRACTOR SHALL STAKE IN THE FIELD FINAL LOCATION OF TREES AND SHRUBS FOR REVIEW AND APPROVAL BY THE LANDSCAPE ARCHITECT PRIOR TO INSTALLATION.
- 10. ALL PLANT MATERIALS SHALL BE WATERED AND MAINTAINED UNTIL ACCEPTANCE
- 11. REPAIR AT NO COST TO OWNER ALL DAMAGE RESULTING FROM LANDSCAPE CONTRACTOR'S ACTIVITIES.
- 12. SWEEP AND MAINTAIN ALL PAVED SURFACES FREE OF DEBRIS GENERATED FROM LANDSCAPE CONTRACTOR'S ACTIVITIES.
- 13. PROVIDE SITE WIDE IRRIGATION SYSTEM DESIGN AND INSTALLATION. SYSTEM SHALL BE FULLY PROGRAMMABLE AND CAPABLE OF ALTERNATE DATE WATERING. THE SYSTEM SHALL PROVIDE HEAD TO HEAD OR DRIP COVERAGE AND BE CAPABLE OF DELIVERING ONE INCH OF PRECIPITATION PER WEEK. SYSTEM SHALL EXTEND INTO THE PUBLIC RIGHT-OF-WAY TO THE EDGE OF PAVEMENT/BACK OF CURB.
- 14. CONTRACTOR SHALL SECURE APPROVAL OF PROPOSED IRRIGATION SYSTEM INLCUDING PRICING FROM OWNER, PRIOR TO

### **IRRIGATION NOTES:**

- 1. ENTIRE SITE SHALL BE FULLY IRRIGATED. THE CONTRACTOR SHALL SUBMIT IRRIGATION SHOP DRAWINGS FOR REVIEW AND APPROVAL BY THE LANDSCAPE ARCHITECT PRIOR TO INSTALLATION.
- 2. SEE MECHANICAL AND ELECTRICAL PLANS AND SPECIFICATIONS FOR IRRIGATION WATER, METER, AND POWER
- CONTRACTOR TO VERIFY LOCATION OF ALL UNDERGROUND/ABOVE GROUND FACILITIES PRIOR TO ANY EXCAVATION/INSTALLATION. ANY DAMAGE TO UNDERGROUND/ABOVE GROUND FACILITIES SHALL BE THE RESPONSIBILITY OF THE CONTRACTOR AND COSTS ASSOCIATED WITH CORRECTING DAMAGES SHALL BE BORNE
- 4. SERVICE EQUIPMENT AND INSTALLATION SHALL BE PER LOCAL UTILITY COMPANY STANDARDS AND SHALL BE PER NATIONAL AND LOCAL CODES. EXACT LOCATION OF SERVICE EQUIPMENT SHALL BE COORDINATED WITH THE LANDSCAPE ARCHITECT OR EQUIVALENT AT THE JOB SITE.
- CONTRACTOR SHALL COORDINATE WITH LOCAL UTILITY COMPANY FOR THE PROPOSED ELECTRICAL SERVICE AND METERING FACILITIES.
- 6. IRRIGATION WATER LINE CONNECTION SIZE IS 1-½" AT BUILDING. VERIFY WITH MECHANICAL PLANS.COVAGE.
- 7. ALL MAIN LINES SHALL BE 18" BELOW FINISHED GRADE.
- 8. ALL LATERAL LINES SHALL BE 12" BELLOW FINISHED GRADE.
- 9. ALL EXPOSED PVC RISERS, IF ANY, SHALL BE GRAY IN COLOR.
- 10. CONTRACTOR SHALL LAY ALL SLEEVES AND CONDUIT AT 2'-0" BELOW THE FINISHED GRADE OF THE TOP OF PAVEMENT. EXTEND SLEEVES TO 2'-0" BEYOND PAVEMENT.
- 11. CONTRACTOR SHALL MARK THE LOCATION OF ALL SLEEVES AND CONDUIT WITH THE SLEEVING MATERIAL "ELLED" TO 2'-0" ABOVE FINISHED GRADE AND CAPPED.
- 12. FABRICATE ALL PIPE TO MANUFACTURE'S SPECIFICATIONS WITH CLEAN AND SQUARE CUT JOINTS. USE QUALITY GRADE PRIMER AND SOLVENT CEMENT FORMULATED FOR INTENDED TYPE OF CONNECTION.
- 13. BACKFILL ALL TRENCHES WITH SOIL FREE OF SHARP OBJECTS AND DEBRIS.
- 14. ALL VALVE BOXES AND COVERS SHALL BE BLACK IN COLOR.
- 15. GROUP VALVE BOXES TOGETHER FOR EASE WHEN SERVICE IS REQUIRED. LOCATE IN PLANT BED AREAS WHENEVER
- 16. IRRIGATION CONTROLLER LOCATION SHALL BE VERIFIED ON-SITE WITH OWNER'S REPRESENTATIVE.
- 17. CONTROL WIRES: 14 GAUGE DIRECT BURIAL, SOLID COPPER IRRIGATION WIRE. RUN UNDER MAIN LINE. USE MOISTURE-PROOF SPLICES AND SPLICE ONLY AT VALVES OR PULL BOXES. RUN SEPARATE HOT AND COMMON WIRE TO EACH VALVE AND ONE (1) SPARE WIRE AND GROUND TO FURTHEST VALVE FROM CONTROLLER. LABEL OR COLOR CODE ALL WIRES.
- 18. AVOID OVER SPRAY ON BUILDINGS, PAVEMENT, WALLS AND ROADWAYS BY INDIVIDUALLY ADJUSTING RADIUS OR ARC ON SPRINKLER HEADS AND FLOW CONTROL ON AUTOMATIC VALVE.
- 19. ADJUST PRESSURE REGULATING VALVES FOR OPTIMUM PRESSURE ON SITE.
- 20. USE SCREENS ON ALL HEADS.
- 21. A SET OF AS-BUILT DRAWINGS SHALL BE MAINTAINED ON-SITE AT ALL TIMES IN AN UPDATED CONDITION.
- 22. ALL PIPE 3" AND OVER SHALL HAVE THRUST BLOCKING AT EACH TURN.
- 23. ALL AUTOMATIC REMOTE CONTROL VALVES WILL HAVE 3" MINIMUM DEPTH OF 3/4" WASHED GRAVEL UNDERNEATH VALVE AND VALVE BOX. GRAVEL SHALL EXTENT 3" BEYOND PERIMETER OF VALVE BOX.
- 24. THERE SHALL BE 3" MINIMUM SPACE BETWEEN BOTTOM OF VALVE BOX COVER AND TOP OF VALVE STRUCTURE.

Landscape Requirements	
Developable Landscape Area (square feet):	14,721
Required Trees:	6
Provided Trees:	14
Required Shrubs:	15
Provided Shrubs:	155


The landscaping requirements are substantially greater than what is listed on the plan. The developable area is equivalent to the site area for this development - 78,691 square feet. Please adjust the landscape plan accordingly. The shrub quantity is met.

LEGEND



EDGING - SHALL BE COMMERCIAL GRADE, 4" DEPTH ALUMINUM, BLACK OR DARK GREEN IN COLOR, INCLUDE ALL CONNECTORS, STAKES, & ALL APPURTENANCES PER MANUF. INSTALL PER MANUF. INSTRUC./SPECS.



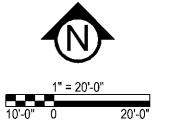

GROUP Civil Engineering · Surveying · Landscape Architecti

5000 Glenwood Avenue Golden Valley, MN 55422

civilsitegroup.com ARCHITECTURE & DESIG

0

I HEREBY CERTIFY THAT THIS PLAN, SPECIFICATION, OR REPORT WAS PREPARED BY ME OR UNDER MY DIRECT SUPERVISION AND THAT I AM A DULY LICENSED LANDSCAPE ARCHITECT UNDER THE LAWS OF THE STATE OF MINNESOTA

DATE 4-26-23 LICENSE NO. 24904

ISSUE/SUBMITTAL SUMMARY DATE DESCRIPTION 3/9/2023 SKETCH PLAN 4/26/2023 PRE-APP DRC SUBMISSION


DRAWN BY: JR, BB REVIEWED BY: MP

ROJECT NUMBER: 23027 REVISION SUMMARY DATE DESCRIPTION

LANDSCAPE PLAN


PLANT SCHE	DULE				
TREES	QTY	COMMON / BOTANICAL NAME	CONT	NATIVE PLANTS	POLLINATOR FRIENDLY
3J	5	Parkland Pillar® Asian White Birch / Betula platyphylla 'Jefpark'	2.5" CAL. B&B	NOT NATIVE	N
GD .	3	Street Keeper Honey Locust / Gleditsia triacanthos `Draves` TM	2.5" Cal. B&B	NATIVE CULTIVAR	N
EK .	3	Espresso Kentucky Coffeetree / Gymnocladus dioica `Espresso`	2.5" Cal. B&B	NATIVE CULTIVAR	N
QP	1	American Dream® Oak / Quercus bicolor 'JFS-KW12'	2.5" CAL. B&B	NATIVE CULTIVAR	N
QS2	2	Kindered Spirit Oak / Quercus robur x bicolor `Nader`	2.5" Cal. B&B	NOT NATIVE	Υ
	•		•	•	•
ORNAMENTAL TREES	QTY	COMMON / BOTANICAL NAME	CONT	NATIVE PLANTS	POLLINATOR FRIENDLY
CV	4	Thornless Cockspur Hawthorn / Crataegus crus-galli inermis TM	1.5" Cal. B&B	NATIVE	Υ
			•	•	
SHRUBS	QTY	COMMON / BOTANICAL NAME	SIZE	NATIVE PLANTS	POLLINATOR FRIENDLY
CA4	6	New Jersey Tea / Ceanothus americanus	#1 CONT	NATIVE	Υ
CA3	19	Arctic Fire Dogwood / Cornus sericea `Arctic Fire`	#5 CONT	NATIVE CULTIVAR	Υ
CB	36	Firedance Dogwood / Cornus sericea `Bailadeline` TM	#5 CONT	NATIVE CULTIVAR	Υ
-C	8	Gold Tide Forsythia / Forsythia x `Courtasol` TM	#2 CONT	NOT NATIVE	Υ
SGJ	31	Sea Green Juniper / Juniperus chinensis `Sea Green`	#5 CONT	NOT NATIVE	N
PR	3	Raspberry Lemonade Ninebark / Physocarpus opulifolius 'ZLEYel2' TM	#5 CONT	NATIVE CULTIVAR	Υ
	•		•		
GRASSES	QTY	COMMON / BOTANICAL NAME	SIZE	NATIVE PLANTS	POLLINATOR FRIENDLY
BB	15	Blonde Ambition Blue Grama / Bouteloua gracilis `Blonde Ambition`	#1 CONT	NATIVE CULTIVAR	Υ
CR	70	Reed Grass / Calamagrostis brachytricha	#1 CONT	NOT NATIVE	N
EH .	8	Bottlebrush Grass / Elymus hystrix	#1 CONT	NATIVE	Υ
N	104	Northwind Switch Grass / Panicum virgatum `North Wind`	#1 CONT	NATIVE CULTIVAR	Υ
SS	18	Smoke Signal Little Bluestem / Schizachyrium scoparium `Smoke Signal`	#1 CONT	NATIVE CULTIVAR	Υ

PLANT SCHEDULE						
GROUND COVERS	COMMON / BOTANICAL NAME	SIZE				
	Decorative Rock Mulch / Decorative Rock Mulch 2"- 4" Dresser Trap Rock, uniform in size over filter fabric. Include aluminum edging as shown on plan, or as needed. Provide Samples.	Mulch				
	Blue Grass Based / Sod Commercial grade, locally grown, well rooted sod blend of improved Kentucky Bluegrass w/ uniform color, leaf texture, density and varieties consisting of a minimum of two and no more than four common cultivars.	Sod				

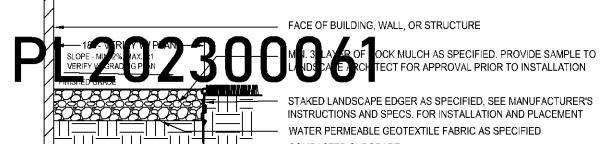

STAKED LANDSCAPE EDGER AS SPECIFIED, SEE MANUFACTURER'S INSTRUCTIONS AND SPECS. FOR INSTALLATION AND PLACEMENT WATER PERMEABLE GEOTEXTILE FABRIC AS SPECIFIED COMPACTED SUBGRADE

AGGREGATE MAINTANENCE STRIP

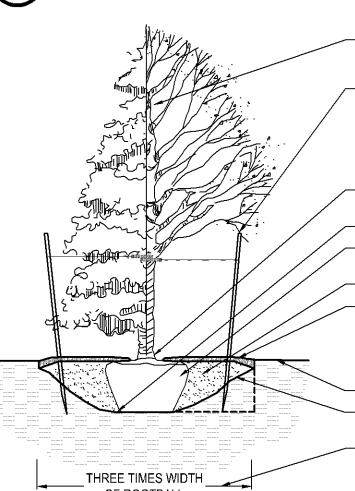

- PRUNE AS FIELD DIRECTED BY THE LANDSCAPE ARCHITECT TO IMPROVE APPEARANCE (RETAIN NORMAL TREE SHAPE)

- THREE 2"X4"X8' WOODEN STAKES, STAINED BROWN WITH TWO STRANDS OF WIRE TWISTED TOGETHER. STAKES SHALL BE PLACED AT 120° TO ONE ANOTHER. WIRE SHALL BE THREADED THROUGH NYLON STRAPPING WITH GROMMETS. ALTERNATE STABILIZING METHODS MAY BE PROPOSED BY CONTRACTOR. TRUNK FLARE JUNCTION: PLANT TREE 1"-2" ABOVE EXISTING GRADE

— COMPACT BOTTOM OF PIT, TYP. — CUT AND REMOVE BURLAP FROM TOP 1/3 OF ROOT BALL. IF NON-BIODEGRADABLE, REMOVE COMPLETELY ── BACKFILL AS SPECIFIED - MULCH TO OUTER EDGE OF SAUCER OR TO EDGE OF

PLANTING BED, IF APPLICABLE. ROCK OR ORGANIC MULCH, SEE GENERAL LANDSCAPE NOTES AND PLAN NOTES FOR MULCH TYPE. KEEP MULCH MIN. 2" FROM PLANT TRUNK - EXISTING GRADE

- SLOPE SIDES OF HOLE OR VERTICAL SIDES AT EDGE OF PLANTING BED - RULE OF THUMB - MODIFY EXCAVATION BASED ON

LOCATION OF PLANT MATERIAL AND DESIGN OF BEDS OR OVERALL PLANT PLACEMENT

OF ROOTBALL **DECIDUOUS & CONIFEROUS TREE PLANTING** 

- PRUNE AS FIELD DIRECTED BY THE LANDSCAPE ARCHITECT TO IMPROVE APPEARANCE (RETAIN NORMAL SHAPE FOR SPECIES) - PLANT TOP OF ROOTBALL 1-2" ABOVE ABOVE

SURROUNDING GRADE - ROCK OR ORGANIC MULCH, SEE GENERAL LANDSCAPE NOTES AND PLAN NOTES FOR MULCH TYPE. KEEP MULCH MIN. 2" FROM PLANT TRUNK


- ROOTS AT OUTER EDGE OF ROOTBALL LOOSENED TO ENSURE PROPER BACKFILL-TO-ROOT CONTACT

- EXISTING GRADE - SLOPE SIDES OF HOLE OR VERTICAL SIDES AT EDGE OF PLANTING BED - BACKFILL AS PER SPECIFICATION

 DO NOT EXCAVATE BELOW ROOTBALL. - RULE OF THUMB - MODIFY EXCAVATION BASED ON LOCATION OF PLANT MATERIAL AND DESIGN OF BEDS THREE TIMES WIDTH LOCATION OF PLANT MATERIAL AN OR OVERALL PLANT PLACEMENT

DECIDUOUS & CONIFEROUS SHRUB PLANTING

NTS

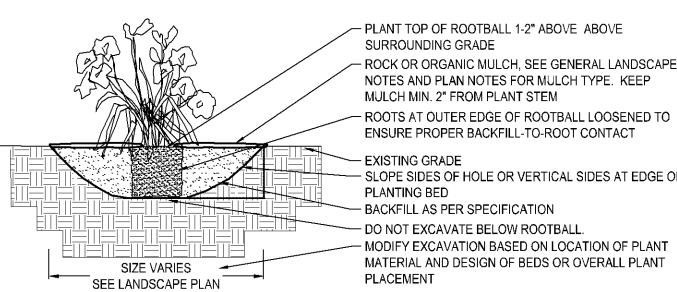


- PLANT TOP OF ROOTBALL 1-2" ABOVE ABOVE SURROUNDING GRADE — ROCK OR ORGANIC MULCH, SEE GENERAL LANDSCAPE NOTES AND PLAN NOTES FOR MULCH TYPE. KEEP MULCH MIN. 2" FROM PLANT STEM

ENSURE PROPER BACKFILL-TO-ROOT CONTACT

- EXISTING GRADE - SLOPE SIDES OF HOLE OR VERTICAL SIDES AT EDGE OF PLANTING BED

- BACKFILL AS PER SPECIFICATION - DO NOT EXCAVATE BELOW ROOTBALL. - MODIFY EXCAVATION BASED ON LOCATION OF PLANT MATERIAL AND DESIGN OF BEDS OR OVERALL PLANT PLACEMENT

PERENNIAL BED PLANTING

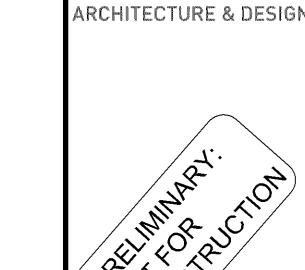

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OPMENT

I HEREBY CERTIFY THAT THIS PLAN, SPECIFICATION, OR REPORT WAS PREPARED BY ME OR UNDER MY DIRECT SUPERVISION AND THAT I AM A DULY LICENSED LANDSCAPE ARCHITECT UNDER THE LAWS OF THE STATE OF MINNESOTA.

DATE 4-26-23 LICENSE NO. 24904

ISSUE/SUBMITTAL SUMMARY DATE DESCRIPTION 3/9/2023 SKETCH PLAN 4/26/2023 PRE-APP DRC SUBMISSION

DRAWN BY:JR, BB REVIEWED BY: MP PROJECT NUMBER: 23027

REVISION SUMMARY DATE DESCRIPTION

> LANDSCAPE PLAN **NOTES & DETAILS**

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